

# **ADDENDUM 2**

September 8, 2020

# RFQ AP 67-20

# FUEL FARM STORAGE SYSTEM MAINTENANCE AND REPAIR at DESTIN-FORT WALTON BEACH AIRPORT (VPS)

Please find attached the Document and information below, for the above referenced Addendum No. 2. This Addendum is hereby made a part of the Contract Documents and Specifications of the above referenced project. All other requirements of the original Contract Documents and Specifications shall remain effective. The purpose of Addendum No. 2 is to set forth changes and/or additional information as referenced herein.

# <u>The last day for questions has been extended from 8 September, 2020 at 3 p.m.</u> <u>C.D.S.T. until 14 September, 2020 at 3 p.m. C.D.S.T.</u>

# Note: The RFP Opening Date & Time remains unchanged.

The Purchasing Department has received the questions stated below as of 4 September, 2020, which are summarized in Item I.

I. <u>Question</u>: "What is the preferred method of bid submittal?"

<u>Answer</u>: Interested Respondents desiring consideration shall provide one (1) original and one (1) thumb drive of their Request for Proposals (RFP) response with the Respondent's proposal.

**<u>Ouestion</u>**: "Who is the current contract provider?"

Answer: There is no current contract provider.

Question: "Who currently holds the contract for the fuel farm maintenance?"

Answer: There has never been a company under contract for this requirement.

**Question:** "What is the location (city) of their main office as it compares to distance from the work site?"

**Answer:** The airport offices are approximately 400 yards from the fuel farm.

**<u>Question</u>:** "Does the current service provider conduct monthly quality metrics and/or KPI meetings with internal sources or POC?"

Answer: There is no current contract or contract provider.

**<u>Question</u>:** "Does the current provider utilize any service cloud-based software capable of giving access to a customer portal?"

Answer: There is no current contract or contract provider.

**<u>Question</u>:** "Does the current provider deploy resources with the service technician such as a technician vehicle, additional parts, service items, etc.?"

Answer: There is no current contract or contract provider.

**Question:** "Is the current service provider able to deploy additional man-power and equipment resources to assist with repair, break/fix, heavy maintenance, if necessary?"

Answer: There is no current contract or contract provider.

**<u>Question</u>:** "Are there separate service providers for tank cleaning, electrical, welding, concrete, fencing repair, annual calibrations, etc.?"

<u>Answer</u>: Barcor Enterprises provided service for tank cleaning and annual fuel farm inspections/calibrations through the purchase order process. Okaloosa County Airport staff ordinates all other.

**<u>Question</u>:** "Does the current service provider hold parts inventory for the fuel farm or store any type of equipment?"

Answer: There is no current contract or contract provider.

**Question:** "Is there a list of parts that we would be required to have "on-hand"?"

<u>Answer</u>: It is the contractor's responsibility to have all of the necessary parts "onhand" to complete all requirements of the service.

**<u>Question</u>**: "What is the hourly bid rate or monthly bill rate from the current service provider?"

Answer: There is no current contract or contract provider.

**<u>Question</u>**: "What is the annual invoiced amount in total from the current service provider (on average)?"

Answer: There is no current contract or contract provider.

Question: "What is the current mark up on parts and material?"

Answer: There is no current contract or contract provider.

**Question:** "What is the term or length of the current contract/bid?"

Answer: There is no current contract or contract provider.

**<u>Question</u>**: "How many employees does the current provider send to the job site for each inspection?"

Answer: There is no current contract or contract provider.

**<u>Question</u>**: "How many employees does the current provider send to the job site for each inspection?"

Answer: There is no current contract provider.

**Question:** "On average, how many times a month/year is the current contractor called out for emergency repair?"

<u>Answer</u>: There is no current contract or contract provider. Historically, the Airport has between 2 to 3 emergency repairs per year.

**Question:** "What is the response time of the current provider for the emergency repair?"

Answer: There is no current contract or contract provider.

Question: "What is the average response time for a break/fix repair?"

Answer: Not applicable because there is no current contract or contract provider

Question: "What is the current age of the equipment and tanks?"

<u>Answer</u>: The 2-MOGAS and 2-JetA tanks are from 2006 and the 2 New JetA tanks were added in 2019.

Question: "What is the current condition of the equipment?

Answer: The current condition is good.

**<u>Question</u>**: "Who was the manufacturer of the tanks and equipment/pumping skids and dispensing equipment?"

Answer: Unknown

**Question:** "Who initially installed the fuel farm?"

Answer: Barcor Enterprises Inc.

**<u>Question</u>**: "What type of meters/registers (electronic or mechanical) do you have on the system?"

Answer: Veeder Root

**Question:** "Do you utilize any tank monitoring, inventory monitoring or electronic Wi-Fi/cell data transfer?"

Answer: No

**<u>Question</u>**: "Do you utilize any back office software we need to be aware of to capture fuel inventory management?"


Answer: Only the previously mentioned Veeder Root

**<u>Question</u>**: "Does the city/county have engineered drawings and controls schematics for the fuel farm and related equipment?"

<u>Answer</u>: Yes – Provided, as attached, within Addendum No. 2. See attached VPS Fuel Farm Original Drawings and the VPS Fuel Farm Expansion, Record Drawings.

**Question:** "Would we be able to send a technician to the site to complete a site survey and/or walk-thru?"


<u>Answer</u>: Yes – The information for the site visit was provided within Addendum No. 1. There will be a site visit scheduled at the VPS Airport on 10 September, 2020 at 2 p.m. C.D.S.T.

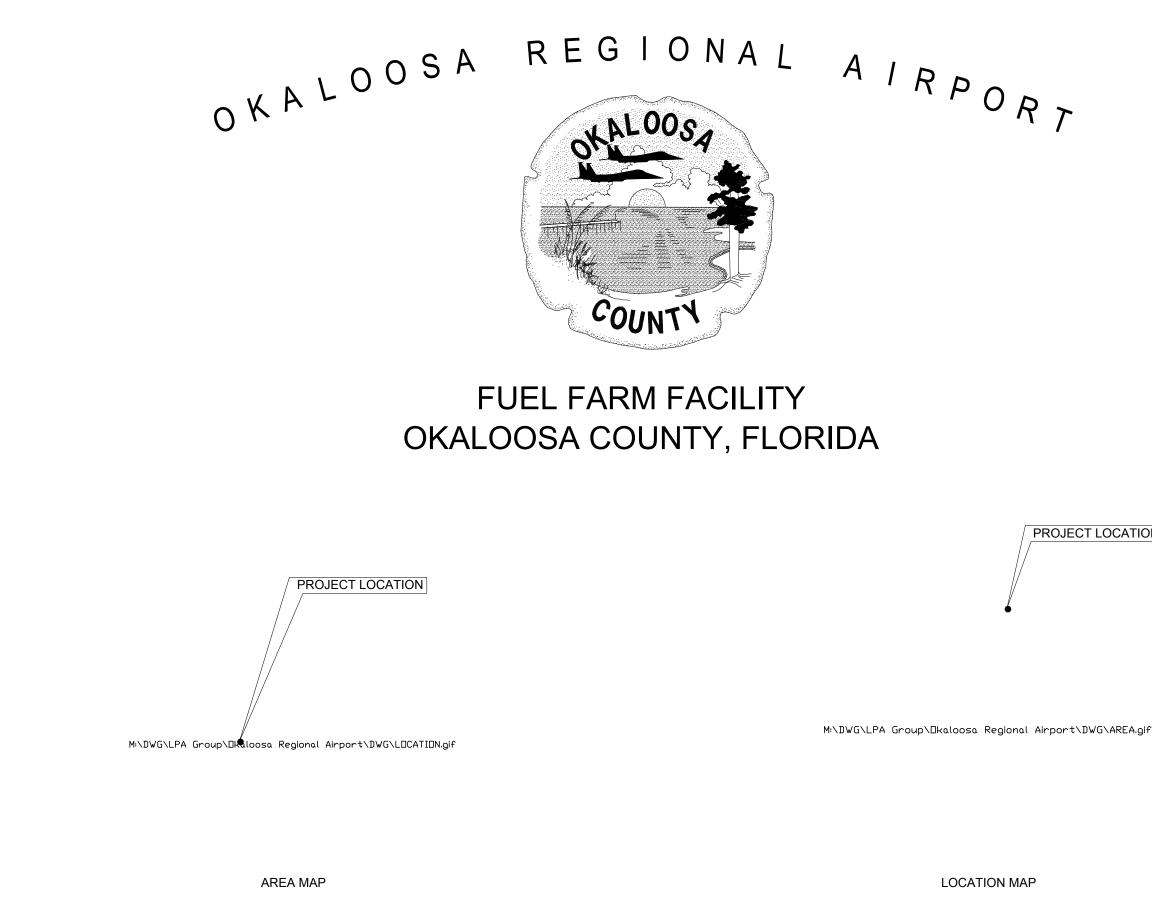

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	TRANSPORTATION CONSULTANTS 2252 KILLEARN CENTER BOULEVARD TALLAHASSEE, FLORIDA 32309 (805) 205–0460 CORPORATE LICENSE NUMBER 00004307					
	Responsive People. Real Partners 3500 Parkway Lane Suite 600 Norcross, Ga. 30092 Phone 678–336–7740 Fax 678–336–7744 Web www.pondco.com					
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PROJECT LOCATION

	DRAWING INDEX – OKALOOSA REGIONAL AIRPORT	
SHEET NUMBER	DESCRIPTION	SCALE
G-001	TITLE SHEET	N/A
G-002	INDEX OF DRAWINGS	N/A
C-001	CIVIL LEGEND, ABBREVIATIONS AND GENERAL NOTES	N/A
C-101	STAKING PLAN	1"=20'
C-102	UTILITY PLAN	1"=20'
C-103	GRADING, DRAINAGE AND EROSION CONTROL PLAN	1"=20'
C-501	CONSTRUCTION DETAILS	N/A
C-502	UTILITY DETAILS	N/A
S-101	STRUCTURAL TANK FARM PLAN	N/A
S-102	STRUCTURAL DETAILS	N/A
S-103	STRUCTURAL DETAILS	N/A
M-001	MECH. LEGEND, ABBREVIATIONS AND GENERAL NOTES	N/A
M-002	FUEL FARM FLOW DIAGRAMS	N/A
M-101	MECHANICAL SITE PLAN	1"=10'
M-102	PUMP ISLAND ENLARGED PLAN	1/2"=1'-0"
M-103	LOADING AND OFFLOADING ENLARGED PLANS	1/2"=1'-0"
M-104	MOGAS DISPENSER SITE PLAN	1"=10'
M-401	TANK LAYOUTS	1/2"=1'-0"
M-501	MECHANICAL DETAILS	N/A
M-502	MECHANICAL DETAILS	N/A
E-001	ELECTRICAL LEGEND AND ABBREVIATIONS	N/A
E-002	HAZARDOUS AREA CLASSIFICATIONS	N/A
E-101	ELECTRICAL POWER & CONTROL PLAN – TANK FARM	1/16"=1'-0'
E-102	ELECTRICAL POWER & CONTROL PLAN – RENTAL CAR FUEL ISLANDS	1"=10'
E-103	GROUNDING PLAN -TANK FARM	1/16"=1'-0'
E-104	GROUNDING PLAN – RENTAL CAR FUEL ISLANDS	1"=10'
E-401	ENLARGED ELECTRICAL POWER PLAN – RENTAL CAR FUEL ISLANDS	1/4"=1'-0"
E-501	ELECTRICAL DETAILS	N/A
E-502	ELECTRICAL DETAILS	N/A
E-503	ELECTRICAL DETAILS	N/A
E-504	ELECTRICAL DETAILS	N/A
E-601	ONE-LINE DIAGRAM	N/A
E-602	PANEL BOARD SCHEDULES	N/A

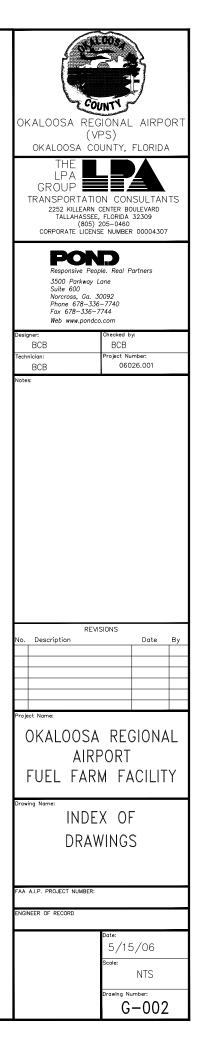



ABBREVIATIONS
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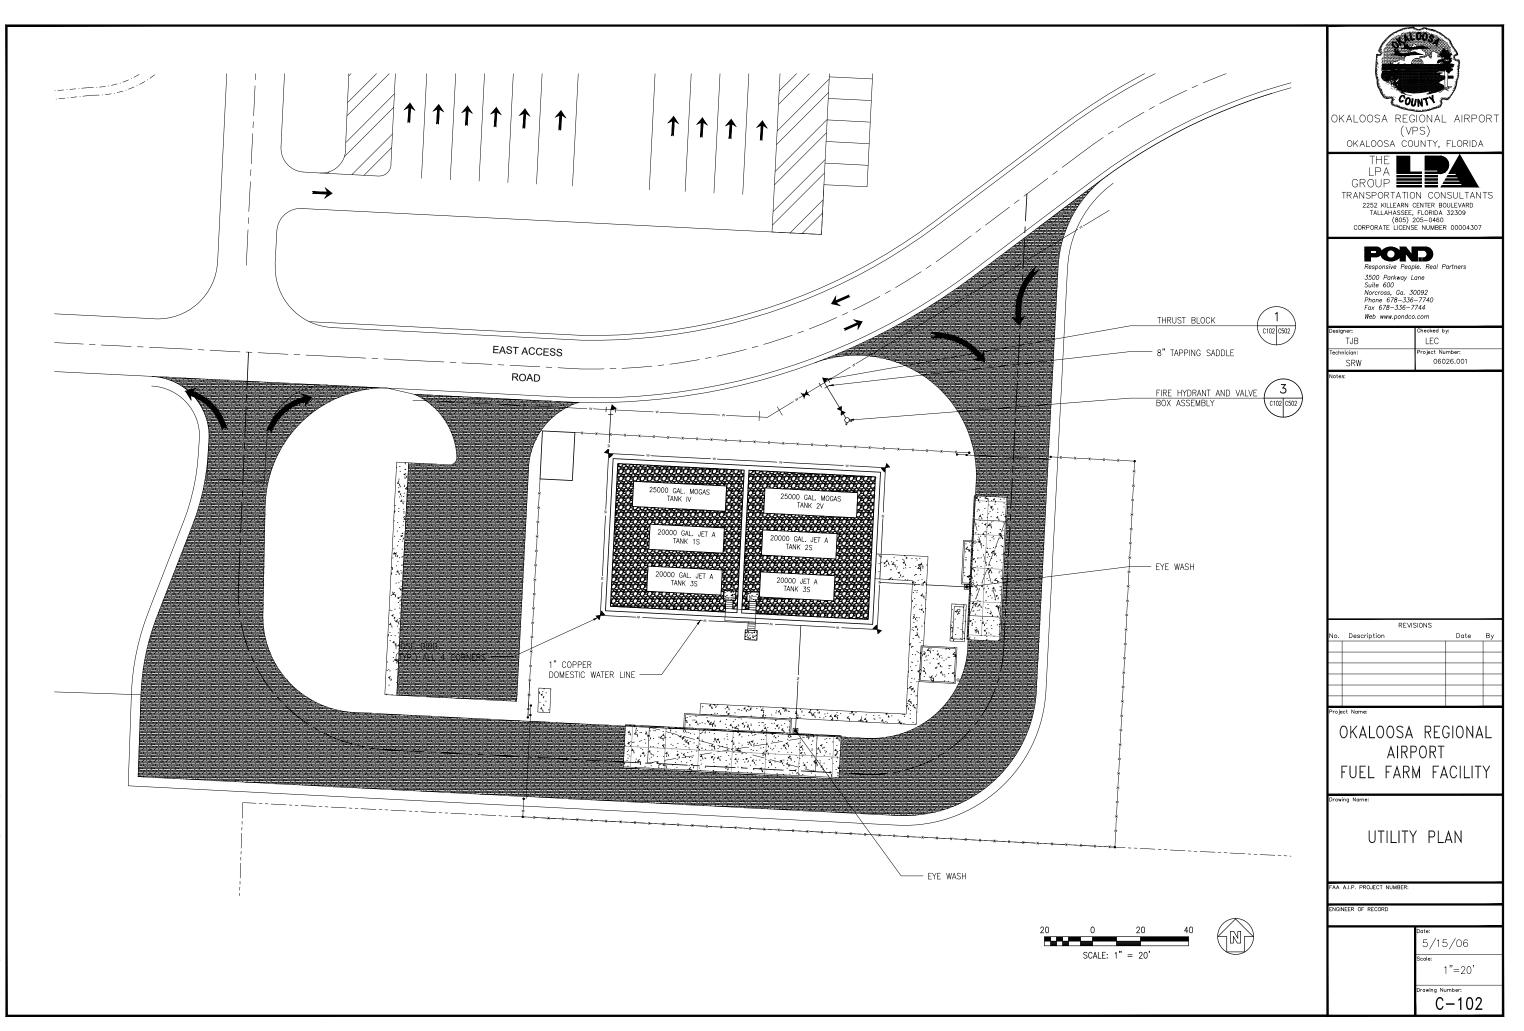
ABBREVIATIONS			CIVIL LEGEND	
AASHTO	AMERICAN ASSOCIATION OF STATE HIGHWAY & TRANSPORTATION OFFICIALS	EXISTING		NEW
ASTM BC	AMERICAN SOCIETY FOR TESTING & MATERIALS BOTTOM OF CURB	N/A	SEWER LINE	— ss ——— ss ———
C.I. C.O.	CAST IRON CLEANOUT	w w		- w w
DIP DW	DUCTILE IRON PIPE DOUBLE WALLED	N/A	SILT FENCE	— SF ———— SF ————
EL. HORIZ	ELEVATION HORIZONTAL	N/A	STORM DRAINAGE LINE	— SD — SD —
I.D. INV.	INSIDE DIAMETER INVERT	N/A	FIRE HYDRANT	
LF MAX	LINEAR FEET MAXIMUM	N/A	DROP INLET	-
MECH. MIN	MECHANICAL MINIMUM	N/A	CLEANOUT	0
M.J. NTS	MECHANICAL JOINT NOT TO SCALE	N/A	THRUST BLOCK	$-\mathbf{k}$
0.C. 0.C.E.W.	ON CENTER ON CENTER EACH WAY	N/A	CONCRETE PAVEMENT	
O.D. PSI	OUTSIDE DIAMETER POUNDS PER SQUARE INCH	N/A	ASPHALT PAVEMENT (HEAVY DUTY)	
PVC R	POLY VINYL CHLORIDE RADIUS	N/A	SILT FENCE	(Sd1-C)
RCP SAN.	REINFORCED CONCRETE PIPE SANITARY	N/A	CONSTRUCTION ENTRANCE	
SD SS	STORM DRAIN SANITARY SEWER	N/A	FENCE	* *
T/G TYP	TOP OF GRATE TYPICAL		MINOR CONTOUR	
VERT W	VERTICAL WATER		MAJOR CONTOUR	
		N/A	GRASSED AREA	


## CIVIL GENERAL NOTES


- 1. ALL TOPSOIL AND EXCAVATED MATERIAL SHALL BE STOCKPILED IN AN APPROVED AREA.
- APPLICABLE TO CONSTRUCTION OF THIS SITE.
- UNLESS OTHERWISE NOTED.
- OF THE WORKDAY.
- SHALL BE PROVIDED, INSTALLED, AND MAINTAINED DURING ALL PHASES OF CONSTRUCTION.
- AVOID DAMAGE OF UTILITIES.
- RECORD DRAWINGS.
- 8. SEE SHEET C-503 FOR EROSION AND SEDIMENT CONTROL NOTES. ALL EROSION CONTROL MEASURES MUST BE IN PLACE PRIOR TO ANY LAND DISTURBANCE.
- AND/OR LOWERED TO BE FLUSH WITH FINISHED GRADES.



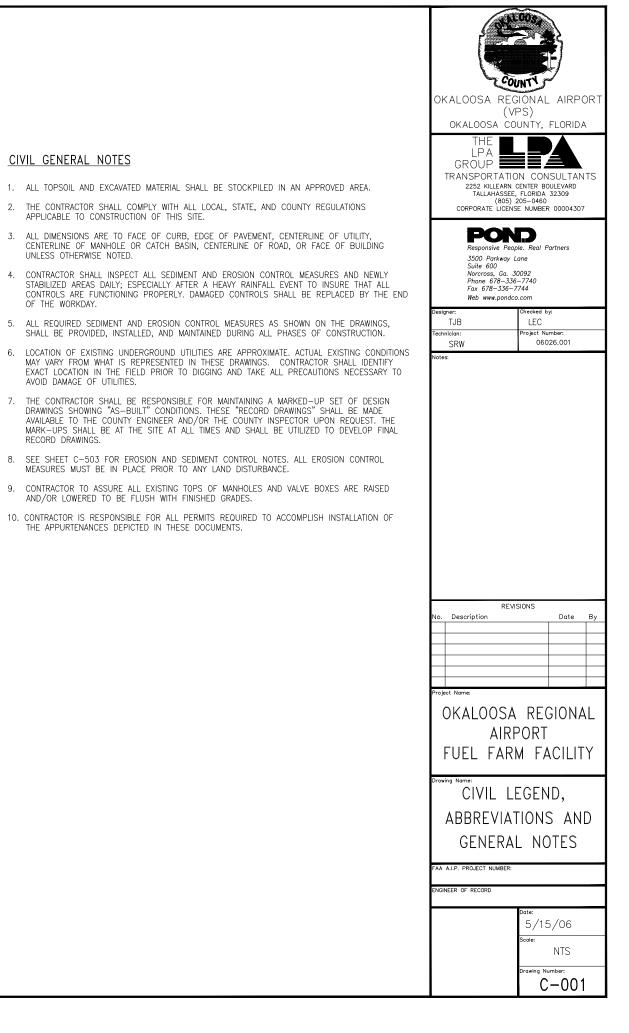


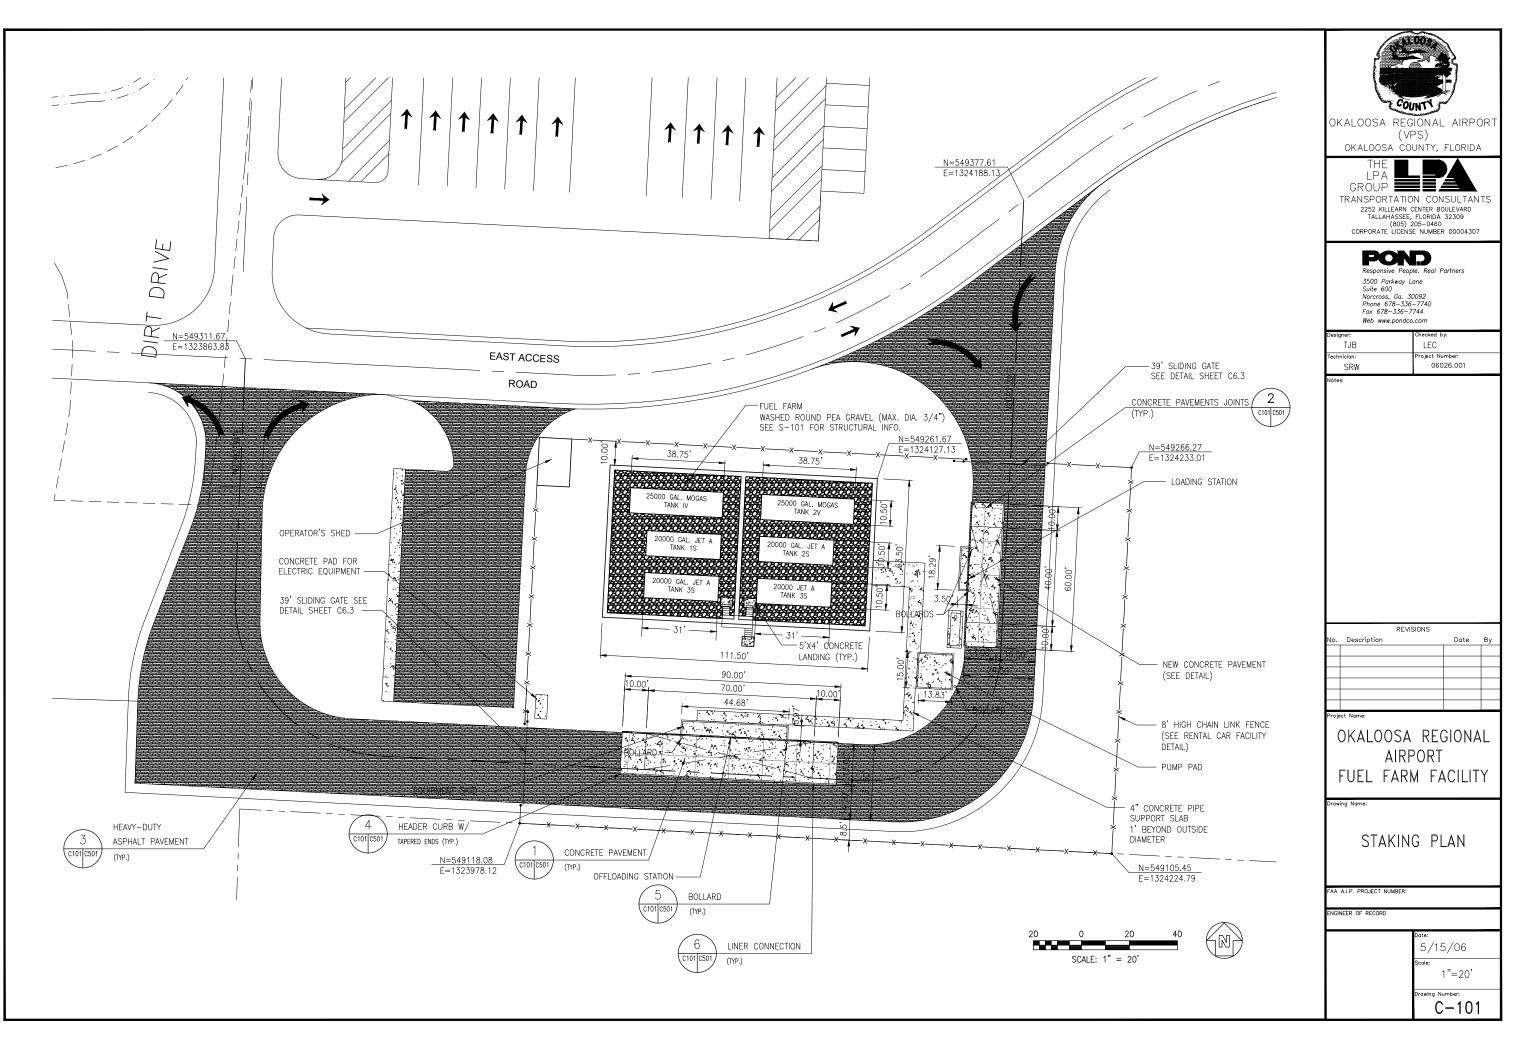

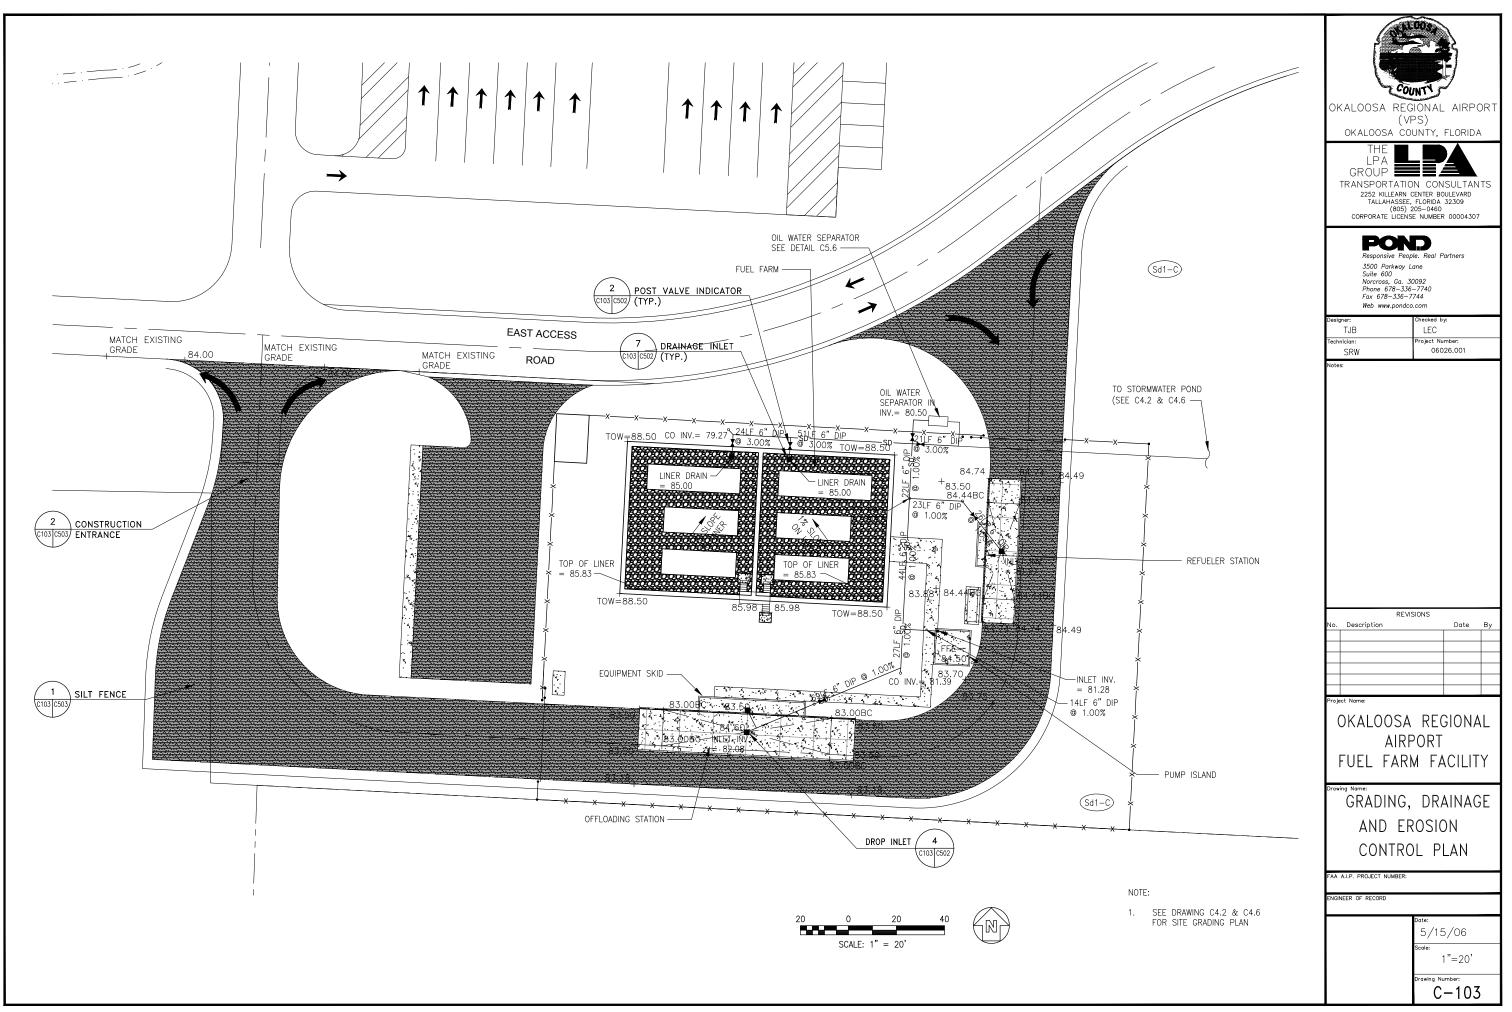

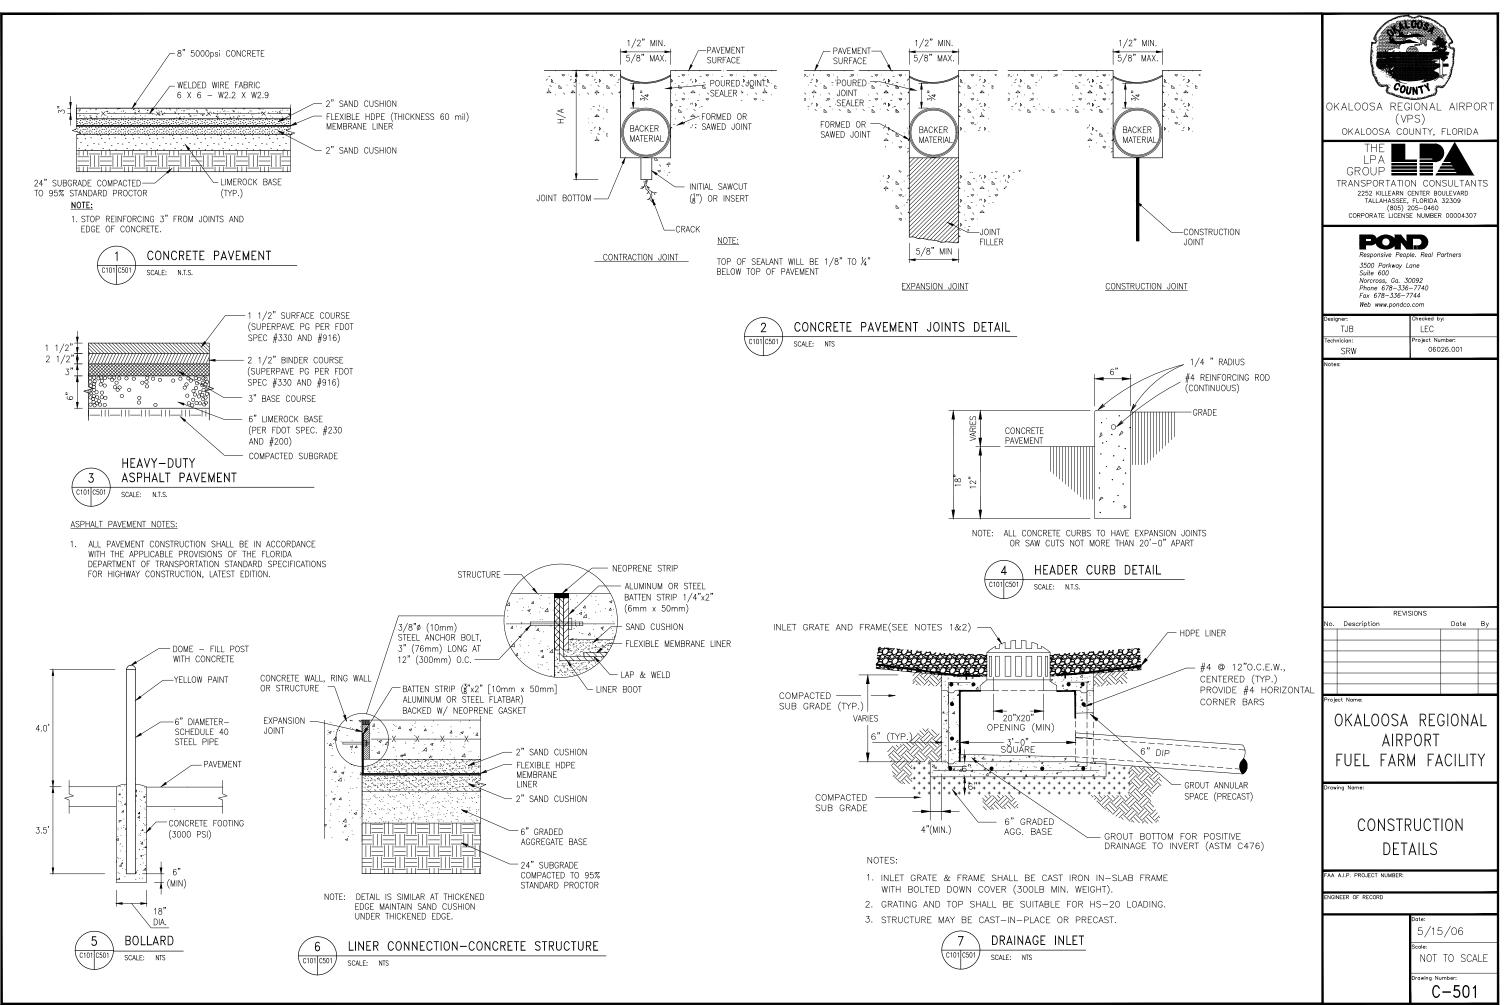



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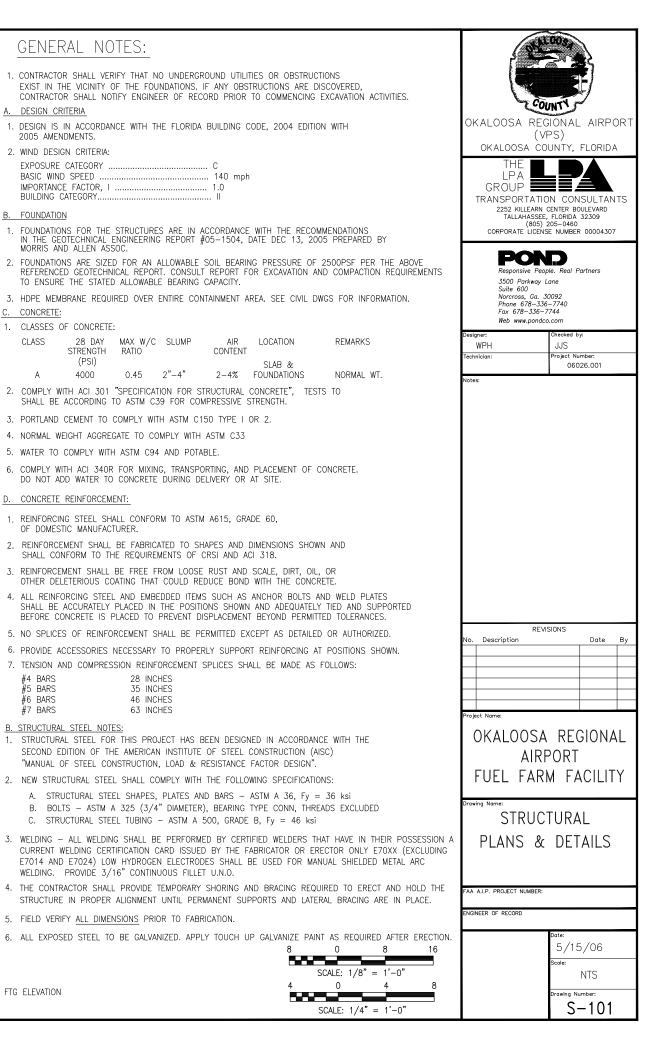


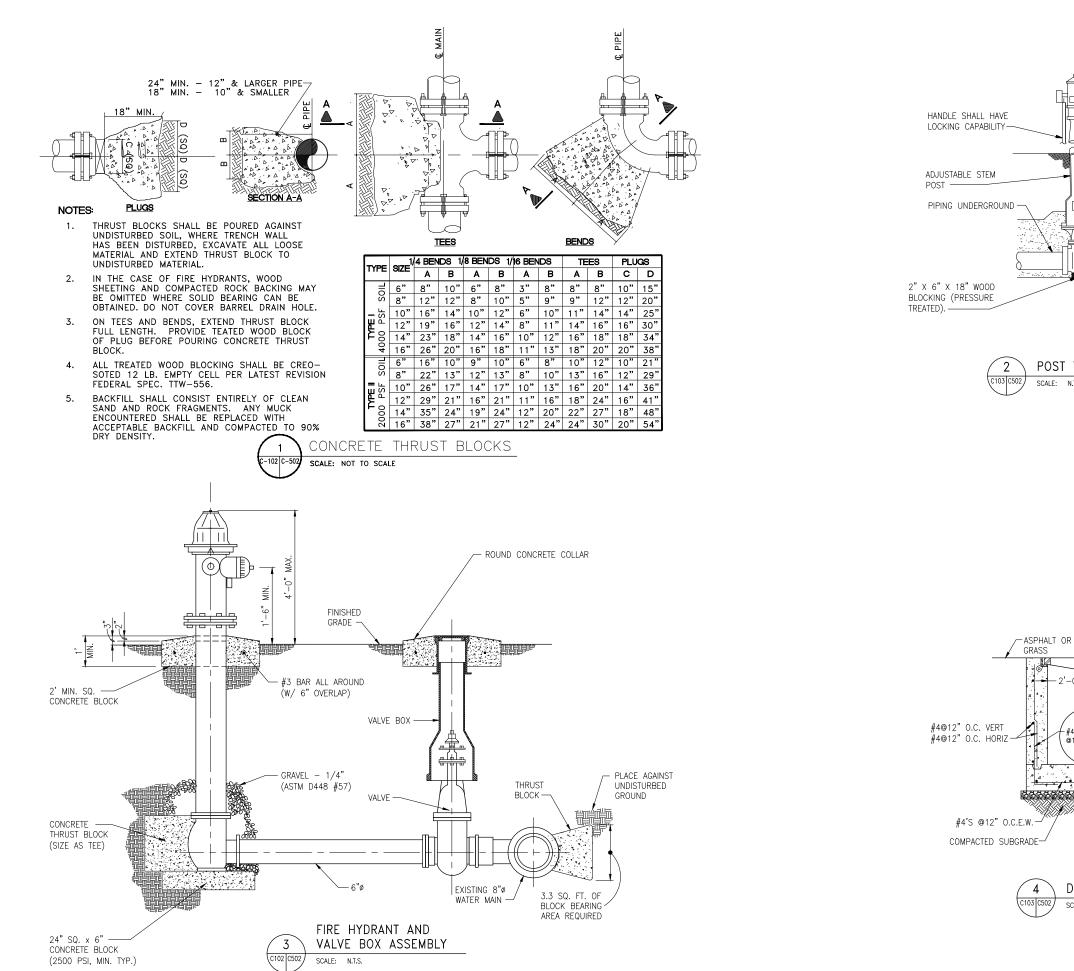SCALE: N.T.S.

2' - 0''



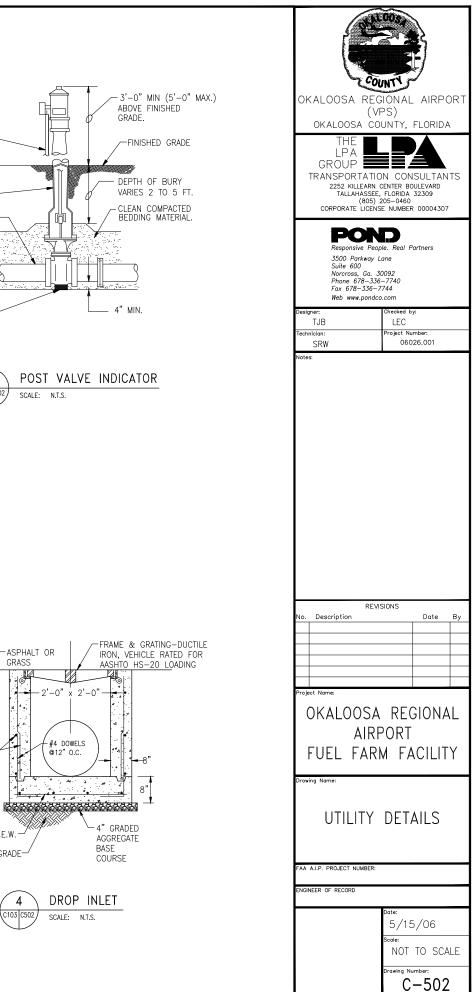

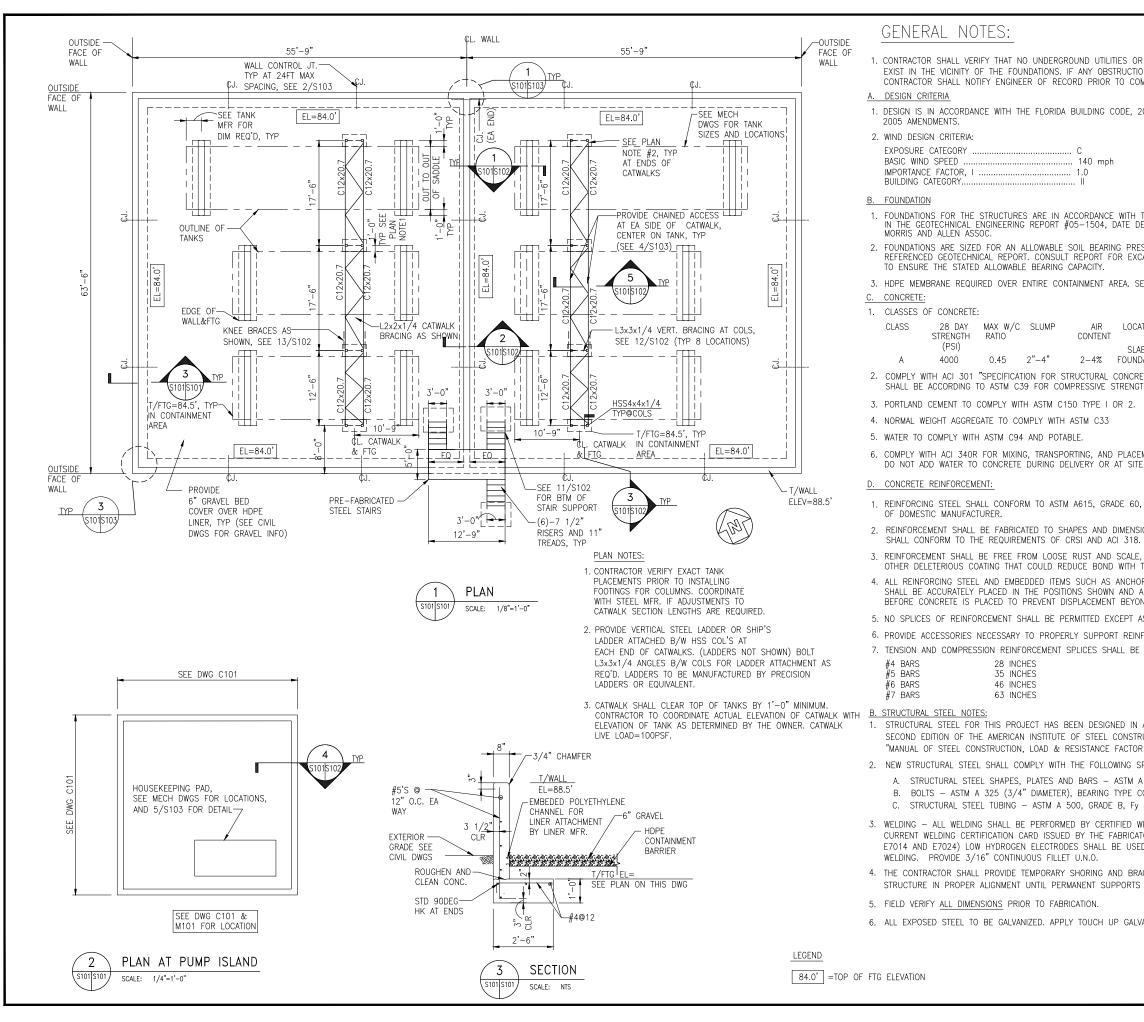

28 DAY

(PSI)

4000

MAX W/C SLUMP

0.45 2"-4"


28 INCHES


35 INCHES

46 INCHES

63 INCHES

RATIO

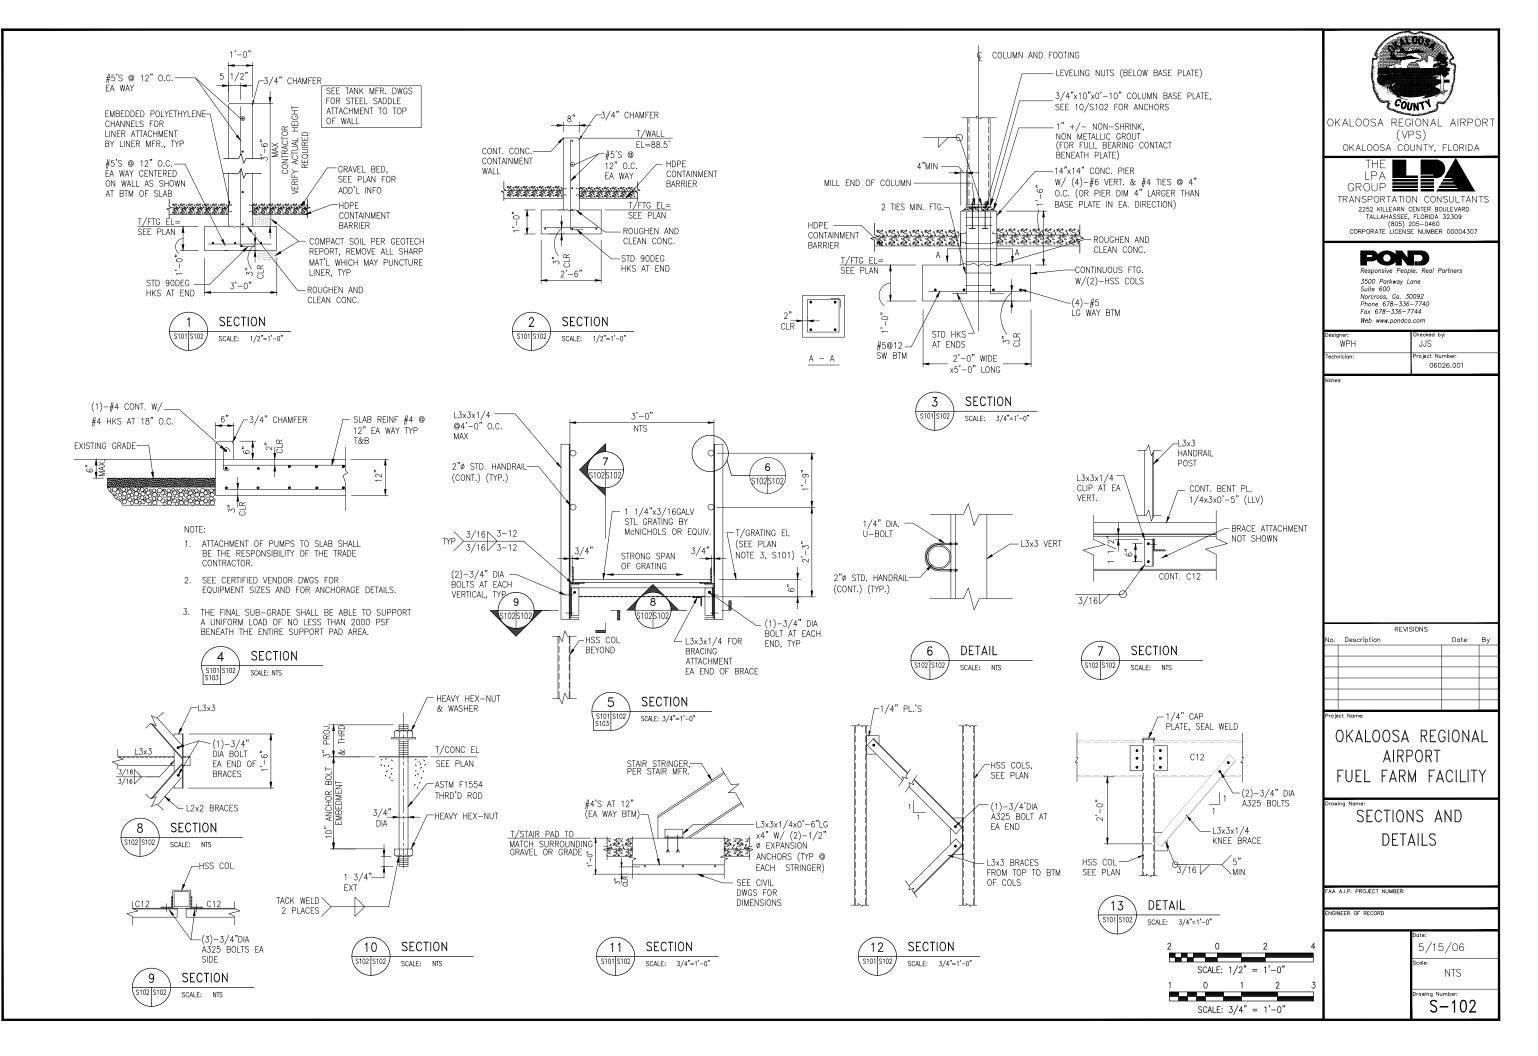

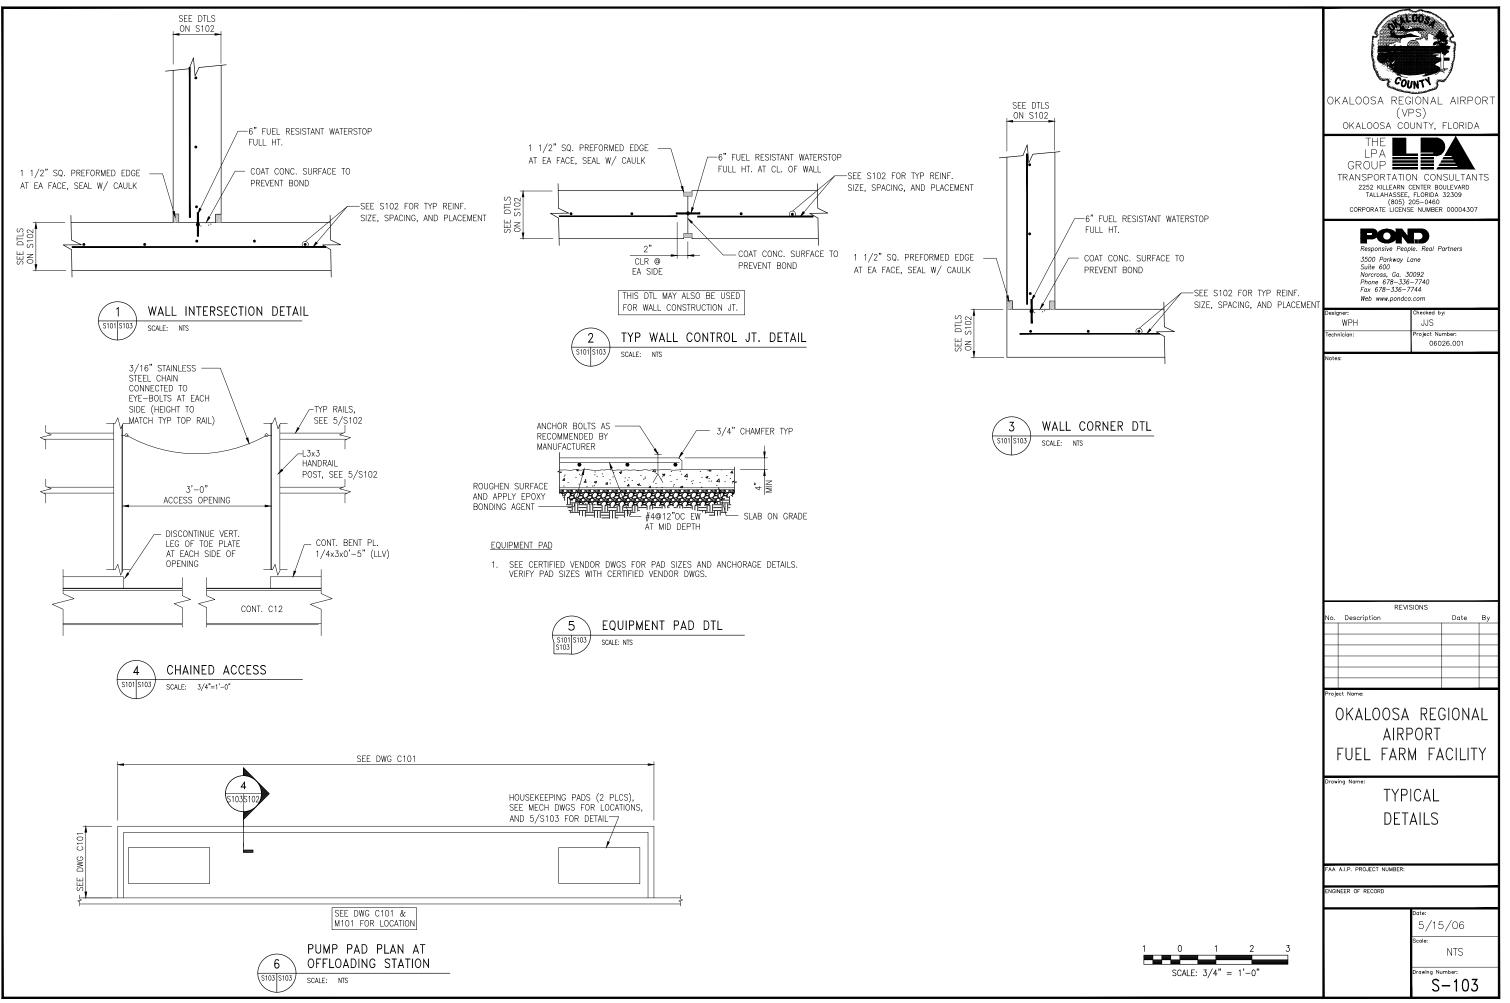

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#### ABBREVIATIONS

AAV AE AFF A/G AGG API ARCH ASTM	AUTOMATIC AIR VENT AIR ELIMINATOR ABOVE FINISHED FLOOR ABOVEGROUND AGGREGATE AMERICAN PETROLEUM INSTITUTE ARCHITECTURAL AMERICAN STANDARDS FOR TESTING AND MATERIALS	IN kW LCV LSH LSH LSL LI LPD
AST ATG AWS AUX B/G	ABOVEGROUND STORAGE TANK AUTOMATIC TANK GAUGING AMERICAN WELDING STANDARDS AUXILIARY BELOW GRADE	LSC MAV MAX MEC MFR
BBL & CLR CMP CO COMM	BARRELS CENTER LINE CLEAR CORRUGATED METAL PIPE CLEANOUT COMMUNICATIONS	MIN N. NC NIC NO
CONM CONC CONN CS CONT CW	CONCRETE CONNECTION CARBON STEEL (LINED) CONTINUATION CLOCKWISE	NPT NTS O/C OCV OD
CV DB DBL DEG DIA	CONTROL VALVE DRY BULB TEMPERATURE DOUBLE DEGREE DIAMETER	OPS PCP PCV PDM PIT PRE
DP DPT DWG DN E.	DIFFERENTIAL PRESSURE DIFFERENTIAL PRESSURE TRANSMITTER DRAWING DOWN EASTING	PRU PRV PSI PDC PRC PRT
ECC ELEV EL EW EX	ĒCCENTRIC ELEVATION ELBOW EACH WAY EXISTING	RED RF SM SS
F F/S FOT FS FSCV	FAHRENHEIT FILTER SEPARATOR FLAT ON TOP FLOW SWITCH FILTER SEPARATOR CONTROL VALVE	STD STL TFV TRV TYP
FTP FP FP0 FCV FSCV	FUEL TRANSFER PUMP FUEL PUMP FUEL PUMP OFFLOAD FLOW CONTROL VALVE FILTER SEPARATOR CONTROL VALVE	U/G VA W/ W/C WDP
GA GC HP HPV	GAGE GENERAL CONTRACTOR HORSE POWER HIGH POINT VENT	WT WWF XS

		LEGEND
IN	INCHES	
kW	KILOWATT	
LCV LSH	LOADING CONTROL VALVE	
LSH	LEVEL SWITCH HIGH LEVEL SWITCH HIGH-HIGH	
LSL	LEVEL SWITCH LOW	-Ñ-
LI LPD	LEVEL INDICATOR (ATG) LOW POINT DRAIN	<u> </u>
LSCV MAV	LOADING STATION CONTROL VALVE MANUAL AIR VENT	¥-
MAV MAX	MAXIMUM	 
MECH MFR	MECHANICAL MANUFACTURER	_K/
MIN	MINIMUM	QĮ
N. NC	NORTHING NORMALLY CLOSED	Å.
NIC	NOT IN CONTRACT	
NO NPT	NORMALLY OPEN NATIONAL PIPE THREAD	
NTS	NOT TO SCALE	
0/C OCV	ON CENTER OFF-LOADING CONTROL VALVE	Т
OD OPS	OUTER DIAMETER OPERATIONS	
PCP	PUMP CONTROL PANEL	
PCV PDM	PRESSURE CONTROL VALVE POSITIVE DISPLACEMENT METER	
PIT	PRESSURE INDICATING TRANSMITTER	
PRESS PRV	PRESSURE PRESSURE RELIEVE VALVE	
PSI	POUNDS PER SQUARE INCH	
PDCV PRCV	PUMP DISCHARGE CONTROL VALVE PRESSURE REDUCING CONTROL VALVE	
PRT RED	PRODUCT RECOVERY TANK REDUCER	
RF	RAISED FACE	-1¤1
SM SS	SIMILAR STAINLESS STEEL	—_   <sup> F</sup>
STD	STANDARD	— <u>o</u> —
STL TFV	STEEL TRUCK FILL VALVE	∝ ORŹ
TRV	THERMAL RELIEF VALVE	丸A
TYP U/G	TYPICAL UNDERGROUND	∆,
VÁ	VALVE	_>
W/ W/O	WITH WITHOUT	$\rightarrow$
WDP	WATER DRAW-OFF PUMP	S
WT WWF	WEIGHT WELDED WIRE FABRIC	ے بو
XS	EXTRA STRONG	¥ ⊏ <sup>¤at</sup> -ore
		01°


	BALL VALVE
—×	BALL VALVE, FULL PORT
	BASKET STRAINER
	CHECK VALVE
—Ř—	CONTROL VALVE
<b>≩</b> −	ANGLE PATTERN CONTROL VALVE
	GLOBE THROTTLING VALVE
_¤ ₽	PLUG VALVE, DOUBLE BLOCK AND BLEED SHEAR VALVE
<del>K,</del>	WYE STRAINER
&	BUTTERFLY VALVE
<b>P</b>	FLOW SWITCH
	ABOVEGROUND PIPE
	UNDERGROUND PIPE
	BLIND FLANGE
	САР
——⊂ —⊠—	QUICK CONNECTOR FLEXIBLE CONNECTION
	UNIVERSAL EXPANSION JOINT
	SAMPLE CONNECTION
IF	INSULATING FLANGE
<u>0</u>	SIGHT FLOW INDICATOR
∝ OR≵	RELIEF VALVE
ÅΑ	RELIEF VALVE SETTING
_>	BALL CHECK RELIEF
<b>&gt;</b>	LINE SIZE REDUCER
S	BASKET STRAINER
Ø	PRESSURE GAUGE
f tat⊸ or ⇔tat⇒	MANUAL AIR VENT
葮	LOW POINT DRAIN
# D	BLEED CONNECTION
(F)	FILTER
	AIRCRAFT ADAPTER
	FUELING HOSE
	SWIVEL JOINT
—)—	90 DEG ELBOW DOWN
— <u>o</u> —	BALL JOINT
ATO	AUTOMATIC TANK GAUGE
(M)	METER
S	SOLENOID
(r) R)	EMERGENCY EYE WASH
DP	DIFFERENTIAL PRESSURE GAUGE
•	CONNECT TO EXISTING

#### GENERAL NOTES

- THESE DRAWINGS ARE DIAGRAMMATIC IN NATURE. NOT ALL COMP SHOWN IN ALL VIEWS. THE CONTRACTOR SHALL MAKE USE OF T OF DRAWINGS AND SPECIFICATIONS AND INCLUDE ALL COMPONENT CONSTRUCT A FULLY OPERATIONAL FUELING SYSTEM.
- 2. THE CONTRACTOR SHALL DEVELOP TO SCALE PIPE FABRICATION FOR APPROVAL PRIOR TO ANY INSTALLATION. SEE SPEC SECTIO ADDITIONAL REQUIREMENTS.
- 3. WRITTEN DIMENSIONS ON DRAWINGS SHALL HAVE PRECEDENCE DIMENSIONS. CONTRACT SHALL FIELD VERIFY DIMENSIONS PRIOR
- 4. THE CONTRACTOR SHALL COORDINATE ALL HIS WORK WITH ALL BEFORE ANY INSTALLATION IS MADE.
- 5. AT START OF CONSTRUCTION, THE CONTRACTOR AND EACH OF SUBCONTRACTORS SHALL PREPARE TYPED LISTS OF ALL EQUIPM ARE SUPPLYING WHICH REQUIRE ELECTRICAL WORK, AND SEND I ELECTRICAL CONTRACTOR FOR HIS REVIEW AND COORDINATION.
- ALL EQUIPMENT SHALL BE INSTALLED IN ACCORDANCE WITH MAY APPROVED PUBLISHED LITERATURE.
- 7. INSTALLATION OF EQUIPMENT SHALL PERMIT ACCESSIBILITY FOR REPLACEMENT.

## SCOPE:


THE MECHANICAL SCOPE INCLUDES BUT IS NOT LIMITED TO: INSTALLATION OF NEW UNLEADED & JET-A TANKS, PUMPS, UNLEADED DISPENSERS, FILL STAND/LOADING STATION, OFF-LOADING STATION AND ALL ASSOCIATED APPURTENANCES.

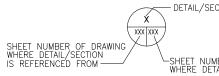



# DETAIL/SECTION IDENTIFICA SHEET NUMBERS OMITTED IF SECTION CUT AND DETAILED ON SAME DRAW


		PUMP SCHEDULE			
DESIGNATION	SERVES	TYPE	SERVICE		
P-1	OFF-LOADING	SELF PRIMING CENTRIFUGAL	MOGAS		
P-2	OFF-LOADING	SELF PRIMING CENTRIFUGAL	JET-A		
P-3	LOADING	SELF PRIMING CENTRIFUGAL	JET-A		
P-4	DISPENSER	SUBMERSIBLE TURBINE PUMP	MOGAS		
P-5	DISPENSER	SUBMERSIBLE TURBINE PUMP	MOGAS		
P-6	DIESEL TANK	SUBMERSIBLE TURBINE PUMP	DIESEL		

	COUNTY -
PONENTS ARE THE ENTIRE SET INTS TO	OKALOOSA REGIONAL AIRPORT (VPS)
SHOP DRAWINGS ON 15060 FOR	OKALOOSA COUNTY, FLORIDA
OVER SCALED TO FABRICATION.	GROUP TRANSPORTATION CONSULTANTS 2252 KILLEARN CENTER BOULEVARD TALLAHASSEE, FLORIDA 32309 (805) 205–0460
OTHER TRADES	CORPORATE LICENSE NUMBER 00004307
HIS MENT THAT THEY LISTS TO THE	<b>PCONDD</b> Responsive People. Real Partners 3500 Parkway Lane Suite 600 Norcross, Ga. 30092 Phone 678–336–7740
NUFACTURER'S	Fax 678–336–7744 Web www.pondco.com
SERVICE AND/OR	Designer: Checked by BCB JDF Technician: Projet Number: BCB 06026.001
-	Notes:
3	
TION NUMBER	
	REVISIONS No. Description Date By
	No. Description Date By
BER OF DRAWING AIL/SECTION IS SHOWN	
TION	
ON IS ING.	OKALOOSA REGIONAL AIRPORT FUEL FARM FACILITY
E FLOW FT. MOTOR GPM HEAD HP	Drawing Name: MECH. LEGEND
300         60         7.5           300         101         15	ABBREVIATIONS
300 192 30	& GENERAL NOTES
5         25         46         3/4           5         25         46         3/4	FAA A.I.P. PROJECT NUMBER:
_ 18 10 1/3	ENGINEER OF RECORD
	Date:
	5/15/06
	Scale:
	Scale: NTS Drawing Number:

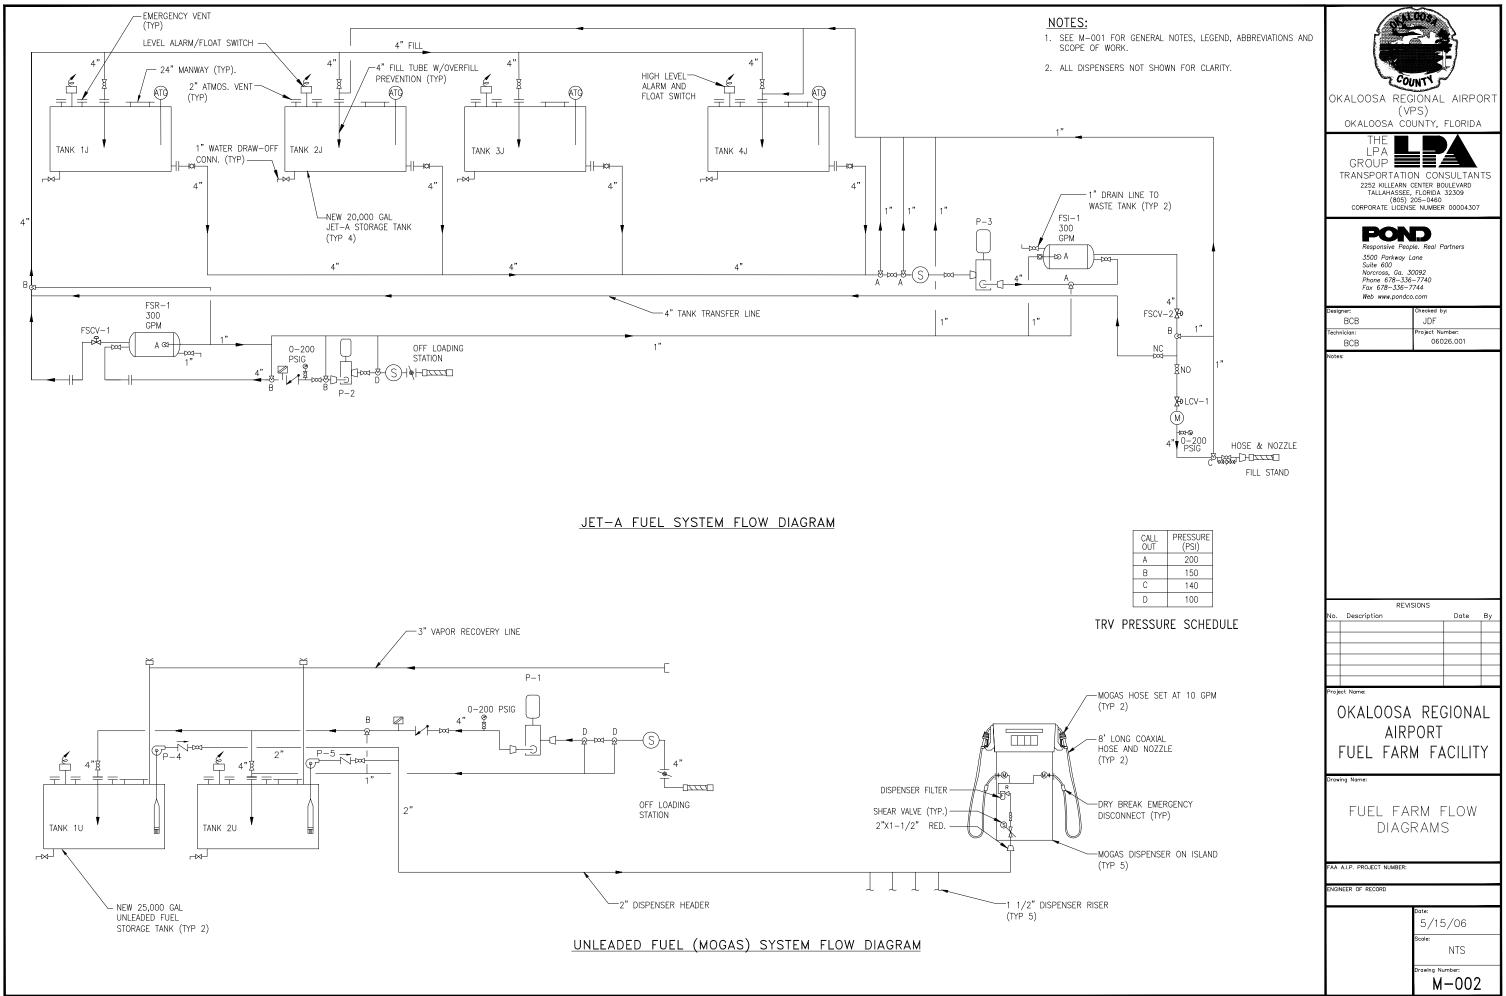


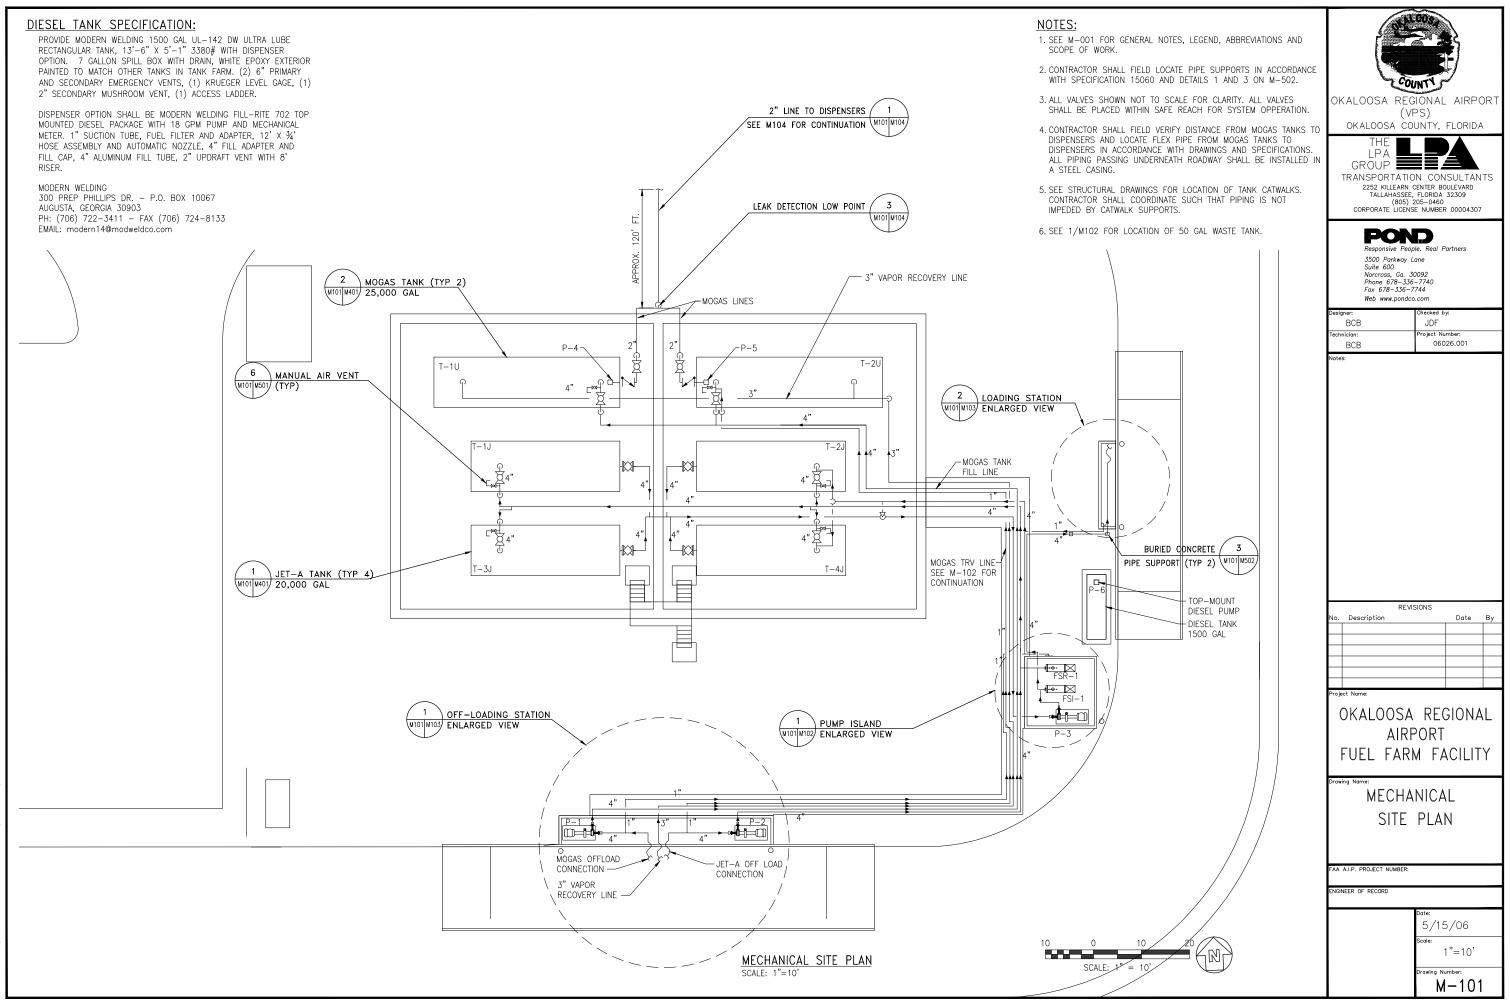


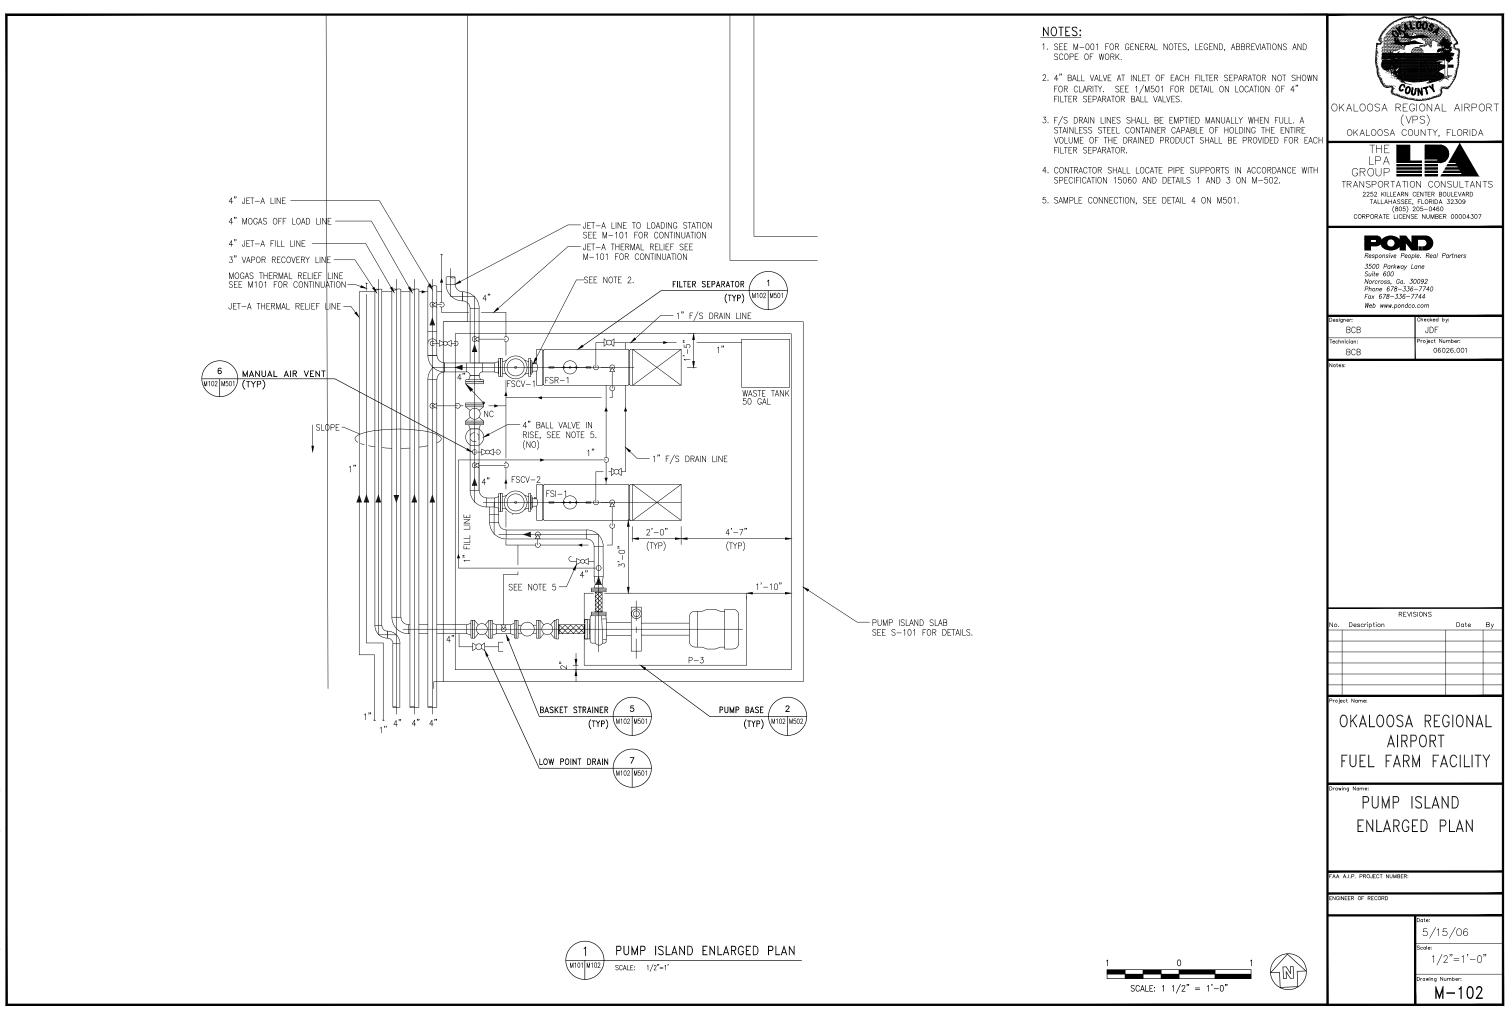

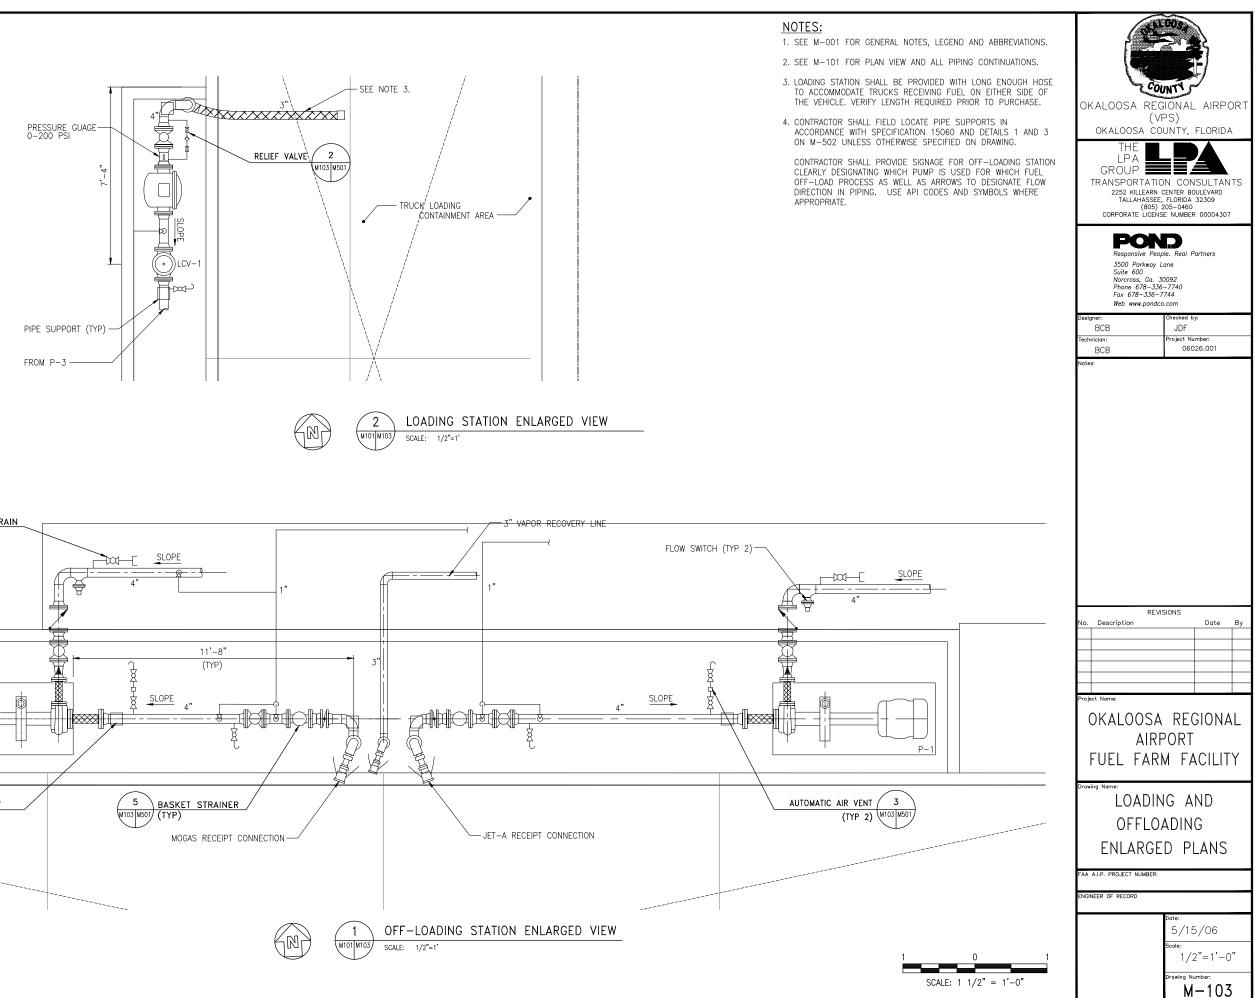




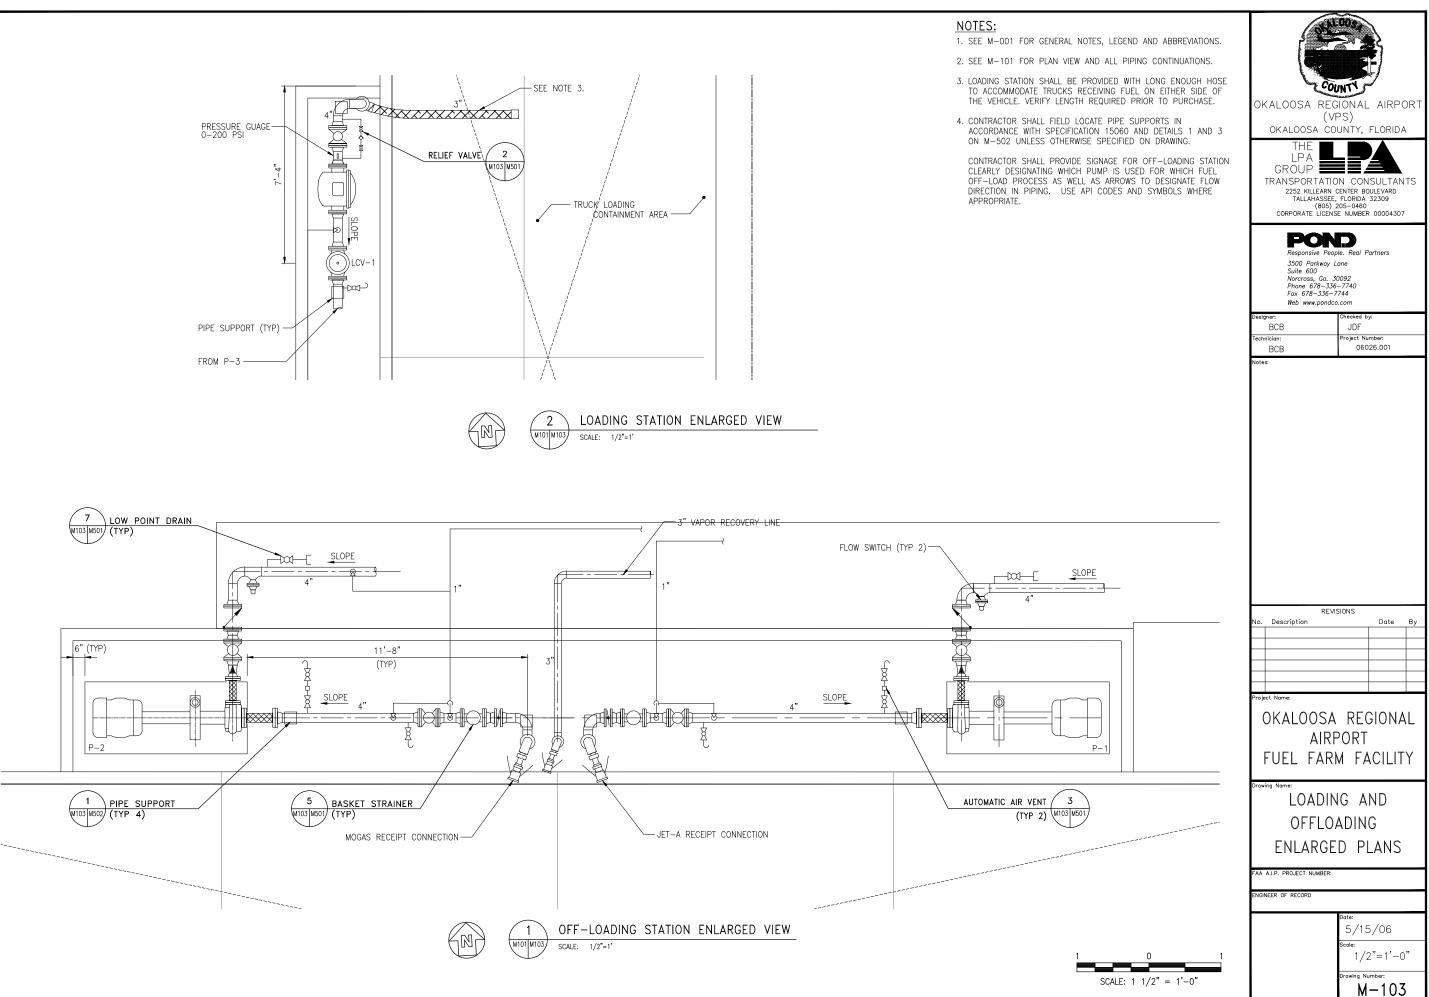


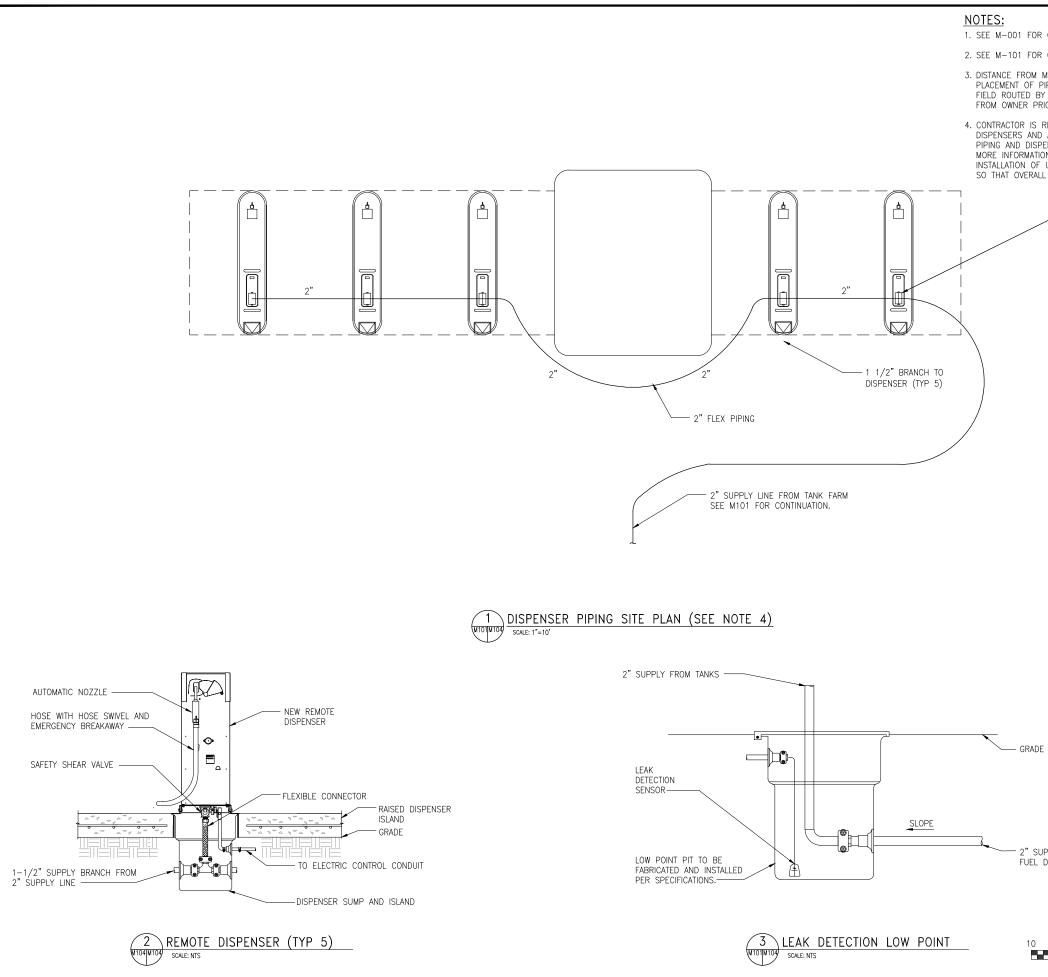


R GENERAL NOTES, LEGEND AND ABBREVIATIONS. R OVERALL PLAN VIEW. MOGAS TANKS TO DISPENSER ISLANDS AND PIPING FROM TANKS TO DISPENSERS SHALL BE BY CONTRACTOR. OBTAIN APPROVAL OF ROUTING RIOR TO INSTALLATION. RESPONSIBLE FOR INSTALLATION AND TESTING OF D ALL ASSOCIATED APPURTENANCES, ALL FUEL PENSER CONTROLS. SEE ELECTRICAL DRAWINGS FOR ION ON CONTROLS. COORDINATE SCHEDULE AND F UNLEADED FUEL SYSTEM WITH OTHER CONTRACTOR LL PROJECT SCHEDULE IS MET. REMOTE DISPENSER 1 (TYP 5)	OK ALOOSA REGIONAL AIRPORT (VPS) OKALOOSA REGIONAL AIRPORT (VPS) OKALOOSA COUNTY, FLORIDA THE LPA GROUP TRANSPORTATION CONSULTANTS 2252 KILLEARN CENTER BOULEVARD TALLAHASSEE, FLORIDA 32309 (BOS) 205-0460 CORPORATE LICENSE NUMBER 00004307 <b>PRONDO</b> CORPORATE LICENSE NUMBER 00004307 <b>PRONDO</b> Responsive People. Real Partners 3500 Parkway Lane Suite 600 Norcross, Ga. 30092 Phone 678-336-7744 Web www.pondo.com		
	Designer: Checked by: BCB JDF		
	Technician: Project Number: BCB 06026.001		
	REVISIONS		
	No. Description Date By		
ΡΕ	Project Nome: OKALOOSA REGIONAL AIRPORT FUEL FARM FACILITY Drawing Name: MOGAS DISPENSER		
UPPLY LINE TO DISPENSERS	SITE PLAN		
	FAA A.I.P. PROJECT NUMBER: ENGINEER OF RECORD		
	Date:		
0 10 20 SCALE: 1" = 10'	5/15/06 Scole: 1"=10' Drawing Number:		
	M-104		

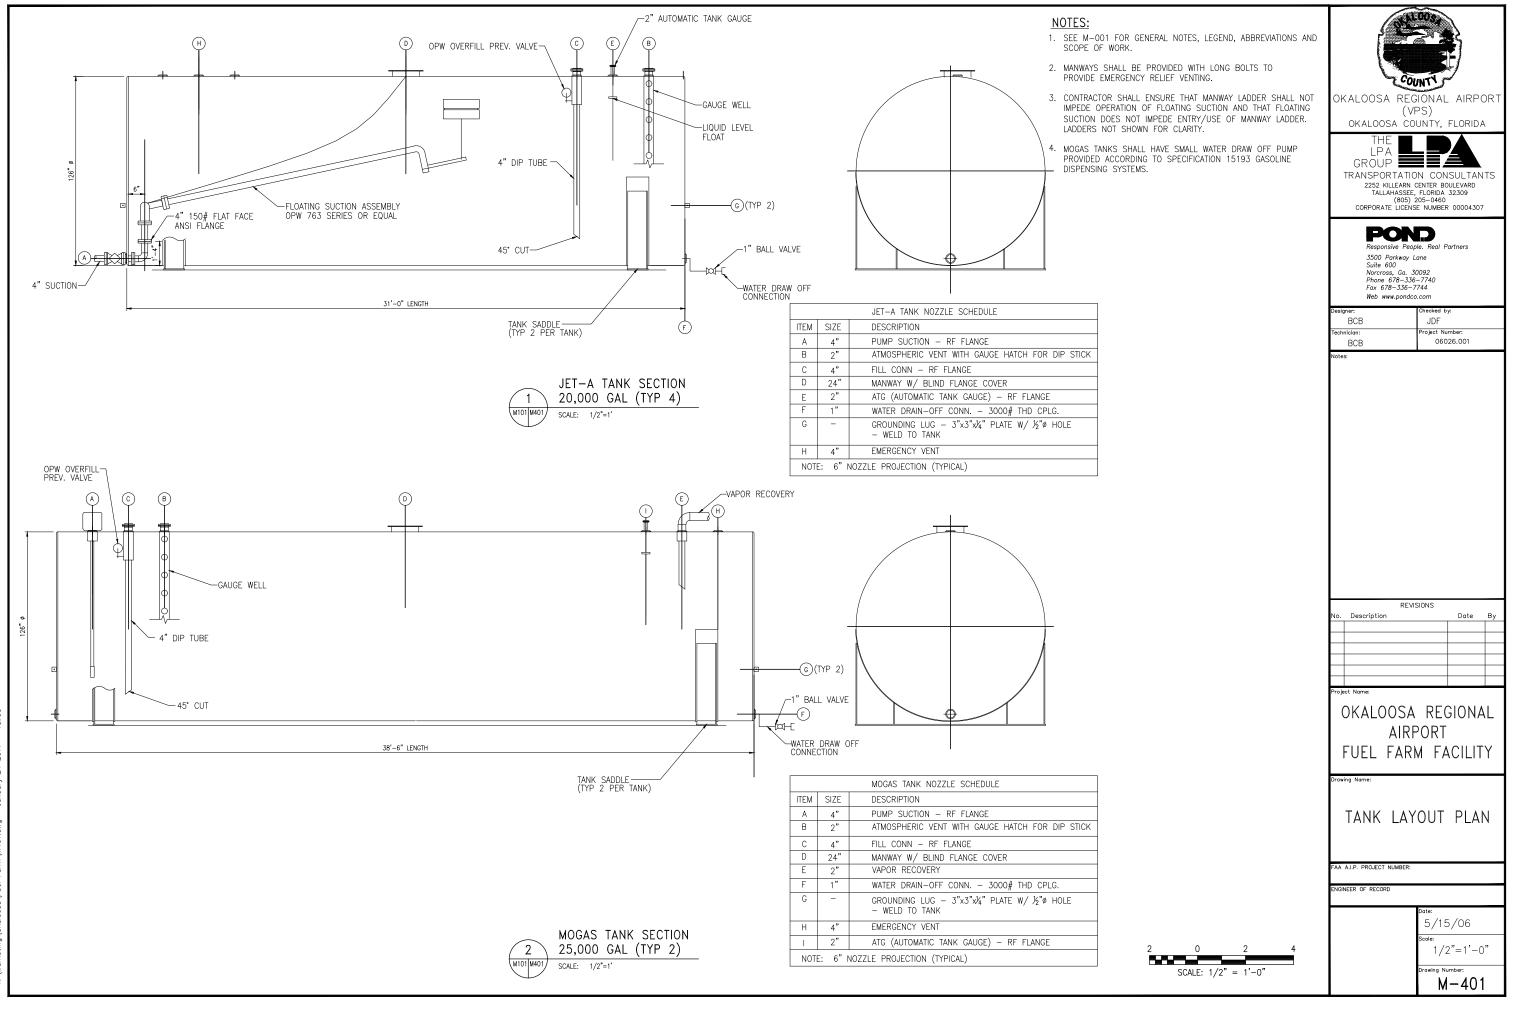

arketing\Okaloosa\Fuel Farm\M401.dwg January 24 2017 -

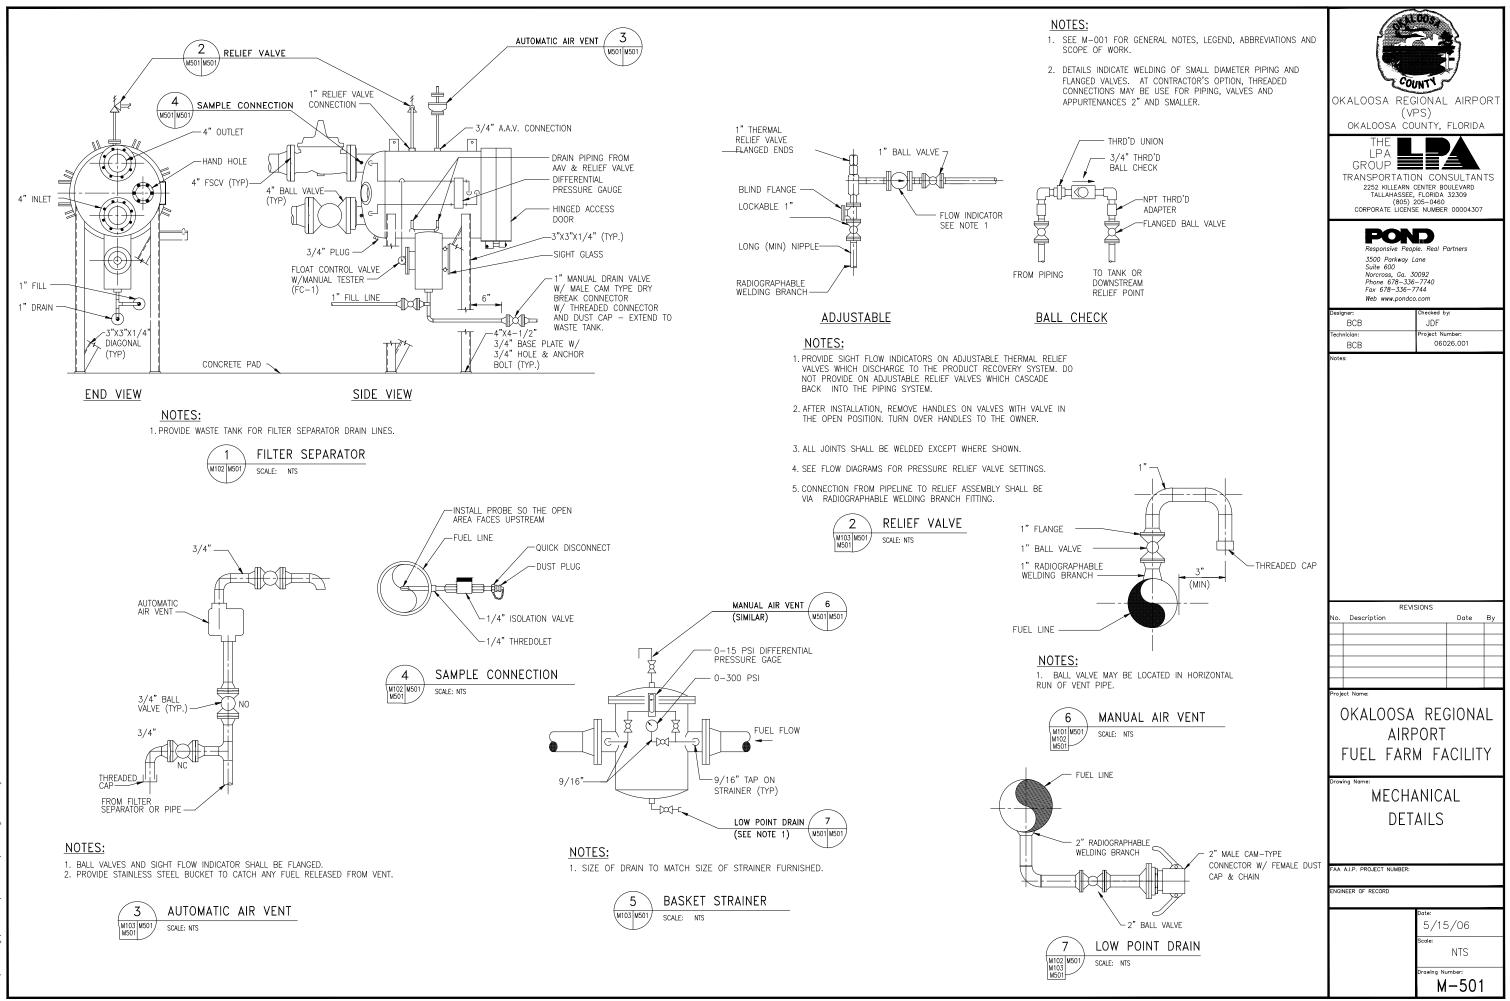

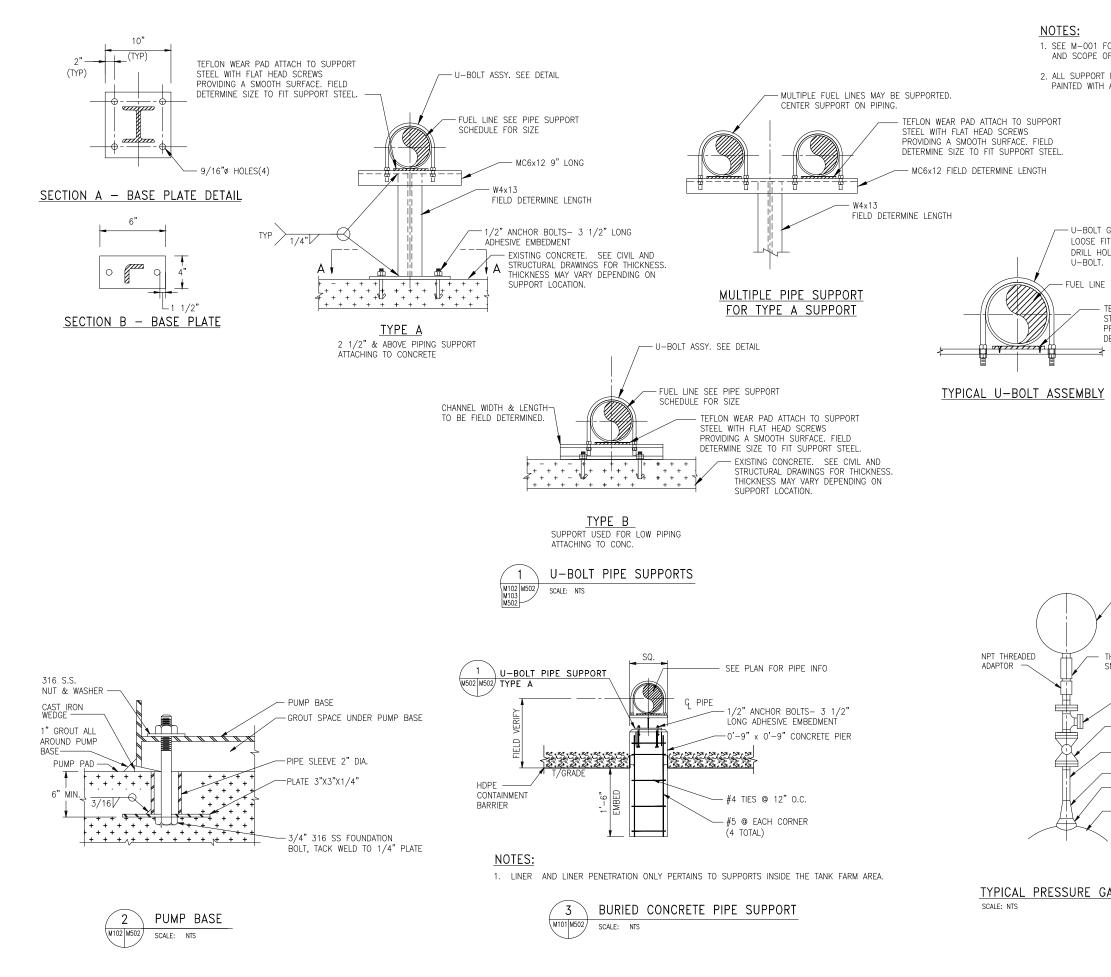

1 FOR GENERAL NOTES, LEGEND, ABBREVIATIONS E OF WORK. ORT MATERIAL SHALL BE ASTM A36 CARBON STEEL TH A ZINC RICH PRIMER.	OKALOOSA REGIONAL AIRPORT (VPS) OKALOOSA COUNTY, FLORIDA THE LPA GROUP TRANSPORTATION CONSULTANTS 2252 KILLEARN CENTER BOULEVARD TALLAHASSEE, FLORIDA 32309 (265) 205-0460 CORPORATE LICENSE NUMBER 00004307
LT GRINNELL FIG 137 OR EQUAL : FIT LEAVE 1/16" GAP ALL AROUND HOLES 1/8" Ø LARGER THAN .T. INE TEELON WEAR RAD ATTACH TO SURPORT	Responsive People. Real Partners 3500 Parkway. Lane Suite 600 Norcross, Ga. 30092 Phone 678–336–7740 Frax 678–336–7744 Web www.pondco.com
- TEFLON WEAR PAD ATTACH TO SUPPORT STEEL WITH FLAT HEAD SCREWS PROVIDING A SMOOTH SURFACE. FIELD DETERMINE SIZE TO FIT SUPPORT STEEL. ☐	BCB         JDF           Technician:         Project Number:           BCB         06026.001           Notes:
4" DIAL OIL FILLED PRESSURE GAGE	REVISIONS No. Description Date By
- THREADED PRESSURE SNUBBER	
BLIND FLANGE BALL VALVE 1/2"X3" NIPPLE	OKALOOSA REGIONAL AIRPORT FUEL FARM FACILITY
REDUCER 1" RADIOGRAPHABLE WELDING BRANCH PIPE	Drowing Norme: MECHANICAL DETAILS
GAUGE DETAIL	FAA A.I.P. PROJECT NUMBER: ENGINEER OF RECORD Date: 5/15/06

	LEGEND			ABBRE	VIATI
SYMBOL	DESCRIPTION	SYMBOL	DESCRIPTION	ABBREVIATION	DESC
<b>-</b> -□	NEW POLE MOUNTED AREA OR FLOODLIGHT FIXTURE BY OTHERS	•	ELECTRICAL CONNECTION	A OR AMP	AMPI ALTE
₽	DUPLEX RECEPTACLE NEMA 5-20R, MTD 18" AFF UNLESS OTHERWISE NOTED	₩ <sub>HT</sub>	MOTOR FRAME TEMPERATURE THERMOSTAT	AC AFF	FLOC
Ф <sup>н</sup>	SPECIALTY RECEPTACLE, NEMA TYPE AS REQUIRED BY EQUIPMENT OR APPLIANCE.			AFG AL	ABO' ALUI
		HOTT	AUTOTRANSFORMER OVERTEMP CONTACT	AIC ATG	AMPI AUTC
JBSCRIPTS	GFI = GROUND FAULT INTERRUPTER; WP = WEATHER PROOF; EWC = ELECTRIC WATER COOLER; EXP = EXPLOSION PROOF; P = RUN PILOT LIGHT		FUSE	BCW BLDG	BARI
C			NORMALLY OPEN CONTACT	С	CON
S	WALL SWITCH AC TYPE, 1-POLE, 20A, 125/277V MT 1219mm (48") AFF	₩ <sup>0.L.</sup>		CB CKT	CIRC
Sm	MOTOR RATED DISCONNECT SWITCH WITH THERMAL OVERLOADS, SINGLE POLE,	H	THERMAL OVERLOAD	COM	COM
	MT ON UNIT UNLESS INDICATED OTHERWISE	H	NORMALLY CLOSED CONTACT	CP CU	CATH COPI
⊖—	4' SURFACE MOUNTED FLUORESCENT FIXTURE			D	DEP
•	EFSO PUSHBUTTON STATION (EMERGENCY FUEL SHUTOFF)	ô	CIRCUIT BREAKER	DC DISC	DIRE
		00	SWITCH	DISP	DISP
M 150	MOTOR, HP AS INDICATED	_		DPST DPDT	DOU DOU
⊠ <sub>2/3R</sub>	3-POLE MAGNETIC MOTOR STARTER (NEMA SIZE/NEMA ENCLOSURE)		NO MOMENTARY PUSHBUTTON	EFSO	EME
	3-POLE COMBINATION MAGNETIC MOTOR STARTER, FUSIBLE TYPE, (NEMA	പ	NC MOMENTARY PUSHBUTTON	ELEC EXIST OR EX	ELEC EXIS
2/1/40	SIZE/NEMA ENCLOSURE/FUSE SIZE), NF = NON-FUSED			EXP	EXPL
		⊶⁄⊸ or s	SOLENOID	F FVNR	FUSE FULL
60/40/3/3R	DISCONNECT SWITCH, (SWITCH AMPS/FUSE SIZE/POLES/NEMA ENCLOSURE), NF = NON-FUSED	°Xro	OVERLOAD HEATER	G OR GND	GRO
		OFF		GFI GRS	GRO GALV
-	PANELBOARD		3-POSITION SELECTOR SWITCH	HP	HORS
	EQUIPMENT AS INDICATED		3-POSITION SELECTOR SWITCH	J OR JB KVA	JUN KILO
_		0 0		KW	KILO'
J <sub>J10</sub>	JUNCTION BOX; BOX NUMBER ADJACENT	~	2-POSITION SELECTOR SWITCH	MLO MT OR MTD	MAIN MOUI
	19mm (3/4") X 3048mm (10"-0") COPPERCLAD GROUND ROD,			N OR NTL	NEU
Ø	458mm (18") BFG.	R	PILOT LIGHT (G=GREEN, R=RED, A=AMBER)	NC NEC	NOR NATI
$\perp$	GROUND CONNECTION	CR	CONTROL RELAY COIL	NEMA	NATE
-			CONTROL RELAT COL	NFPA	ASS ASS
- G	#1/0 BARE COPPER GROUND CONDUCTOR, UIO #4/0 BARE COPPER GROUND CONDUCTOR	TDR	TIME DELAY RELAY COIL	NIC	NOT
- G4 ——	#4/0 BARE COPPER GROUND CONDUCTOR	MC	MOTOR STARTER COIL	NO NTS	NOR NOT
ullet	LIGHTNING PROTECTION AIR TERMINAL	-		PNL	PAN
	ALARM HORN		LIGHTING CONTACTOR COIL	PSI PVC	POU CHL
	ALAKM HUKN			RVNR	RED
- · _	RACEWAY EXPOSED		PUSH-TO-TEST	SHLD SPDT	SHIE
			PILOT LIGHT	SPST	SING
	RACEWAY CONCEALED BELOW SLAB/GRADE			SWBD TVSS	SWIT TRAN
	DUCTBANK – CONCRETE ENCASED			TP	TWIS
0	RACEWAY TURNED TOWARD VIEWER			TSP UG	TWIS UNDE
-				UL	UND
				1110	LINIC

RACEWAY TURNED AWAY FROM VIEWER

SEAL FITTING

UNION FITTING

RACEWAY TERMINATION, STUB-OUT AND CAP

FLEXIBLE METAL CONDUIT (SEE SPECIFICATION

FOR AREAS REQUIRING LIQUIDTIGHT)

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\_\_\_\_\_

\_\_\_\_

\_\_\_\_||\_\_\_\_\_

MATTHERE

#### SED D TIONS SCRIPTION **IPERES** COUNTY TERNATING CURRENT ABOVE FINISHED LOOR BOVE FINISHED GRADE OKALOOSA REGIONAL AIRPORT (VPS) LUMINUM MPERES INTERRUPTING CAPACITY UTOMATIC TANK GAUGING BARE COPPER WIRE OKALOOSA COUNTY, FLORIDA THE LPA GROUP JILDING ONDUIT RCUIT BREAKER RCUIT TRANSPORTATION CONSULTANTS 2252 KILLEARN CENTER BOULEVARD TALLAHASSEE, FLORIDA 32309 OMMON (805) 205–0460 CORPORATE LICENSE NUMBER 00004307 THODIC PROTECTION OPPER EPTH RECT CURRENT SCONNECT SWITCH POND Responsive People. Real Partners Kesponsive recple. Ked 3500 Parkway Lane Suite 600 Norcross, Ga. 30092 Phone 678–336–7740 Fax 678–336–7744 Web www.pondco.com SPENSER OUBLE POLE SINGLE THROW OUBLE POLE DOUBLE THROW MERGENCY FUEL SHUT-OFF LECTRICAL KISTING PLOSION PROOF WBC KJZ JSE roject Number: ILL VOLTAGE NON-REVERSING 06026.001 ROUND GROUND GROUND-FAULT-INTERRUPTER GALVANIZED RIGID STEEL HORSEPOWER JUNCTION BOX KILOVOLT - AMPERES KILOWATTS GAUNALIUS CONTY ILOWATTS IAIN LUGS ONLY IOUNT OR MOUNTED EUTRAL ORMALLY CLOSED ATIONAL ELECTRICAL CODE ATIONAL ELECTRICAL CODE ATIONAL ELECTRICAL MANUFACTURERS SSOCIATION NATIONAL FIRE PROTECTION SSOCIATION SSOCIATION DT IN CONTRACT DRMALLY OPEN OT TO SCALE NELBOARD OUNDS PER SQUARE INCH POLYVINYL HLORIDE EDUCED VOLTAGE NON-REVERSING HIELDED INGLE POLE DOUBLE THROW INGLE POLE SINGLE THROW VITCHBOARD REVISIONS RANSIENT VOLTAGE SURGE SUPPRESSION Description Date By WISTED PAIR WISTED SHIELD PAIR NDERGROUND UNDERWRITER'S LABORATORIES UNSHIELDED TWISTED PAIR VOLTS VOLT-AMPERES WATTS OR WIDTH OR WIRE Project Name: WEATHER PROOF OKALOOSA REGIONAL AIRPORT FUEL FARM FACILITY wing Name: ELECTRICAL LEGEND AND ABBREVIATIONS AA A.I.P. PROJECT NUMBER: NGINEER OF RECORD


UTP

V

VA

W WP

> Date: 5/15/06 Scale: NOT TO SCALE Draving Number: E-001

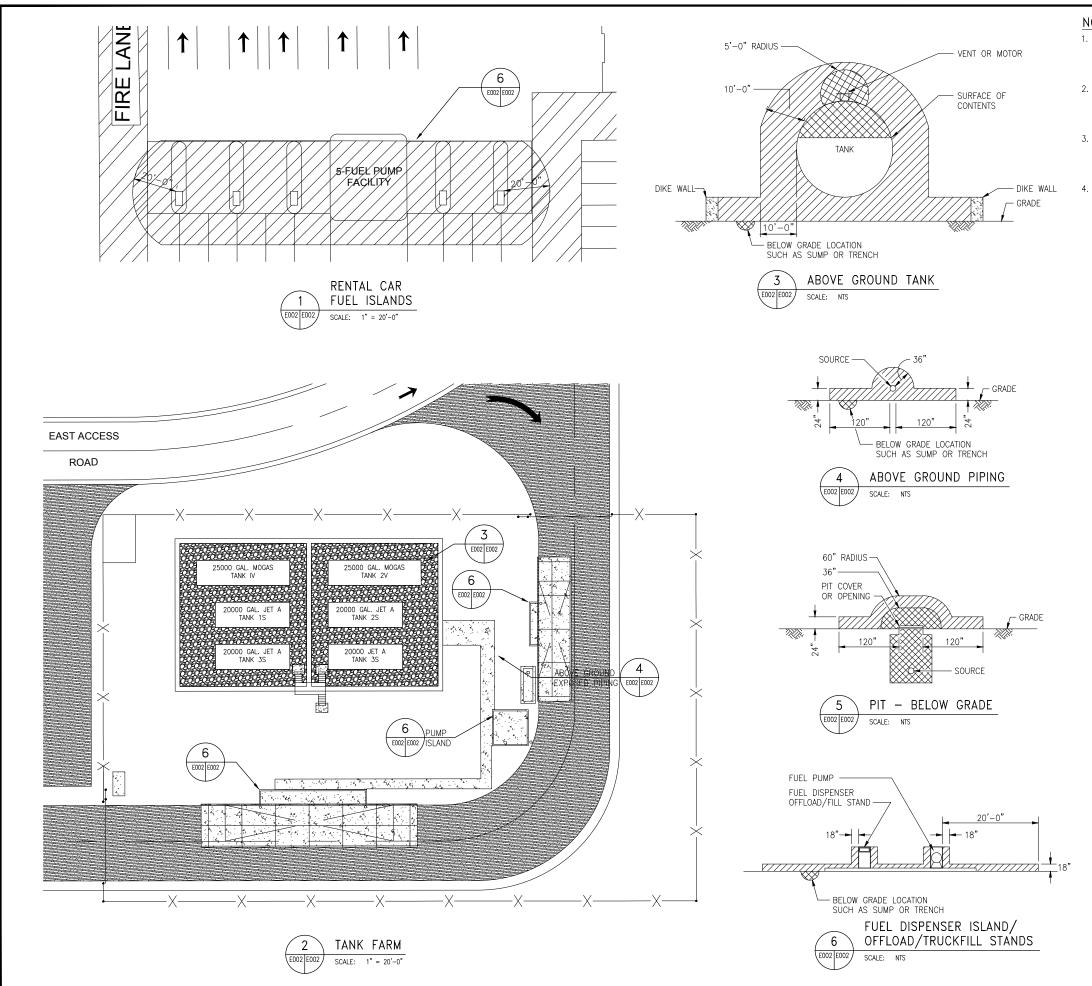

## NOTES:

ALL ELECTRICAL WORK IN HAZARDOUS AREAS SHALL BE IN ACCORDANCE WITH NATIONAL ELECTRICAL CODE ARTICLE 501 FOR CLASSIFICATION INDICATED.

2. PIT DETAIL APPLIES TO HIGH POINT, LOW POINT, ISOLATION VALVE PITS AND O/W SEPARATOR. REFER TO CIVIL AND MECHANICAL PLANS FOR PIT LOCATIONS.

 DETAIL APPLIES TO ABOVEGROUND PIPING WITH VALVES, SCREWED FITTINGS, FLANGES OR SIMILAR ACCESSORIES. REFER TO CIVIL AND MECHANICAL PLANS FOR PIPING.


SEE E-001 FOR LEGEND, ABBREVIATIONS AND GENERAL NOTES.

## CLASSIFICATION LEGEND:


CLASS I, DIVISION 1, GROUP D HAZARDOUS AREA (T2D, 251°C (419°F) MAX.)


CLASS I, DIVISION 2, GROUP D HAZARDOUS AREA (T2D, 251°C (419°F) MAX.)

NONCLASSIFIED AREA

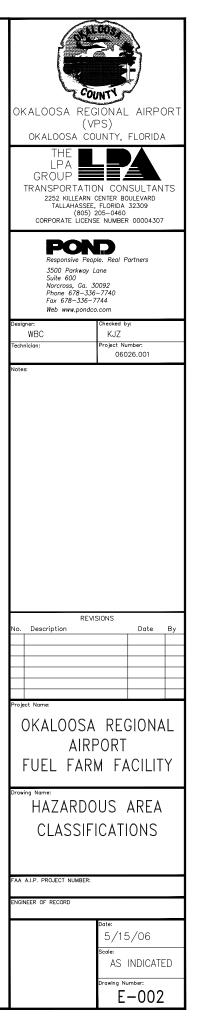





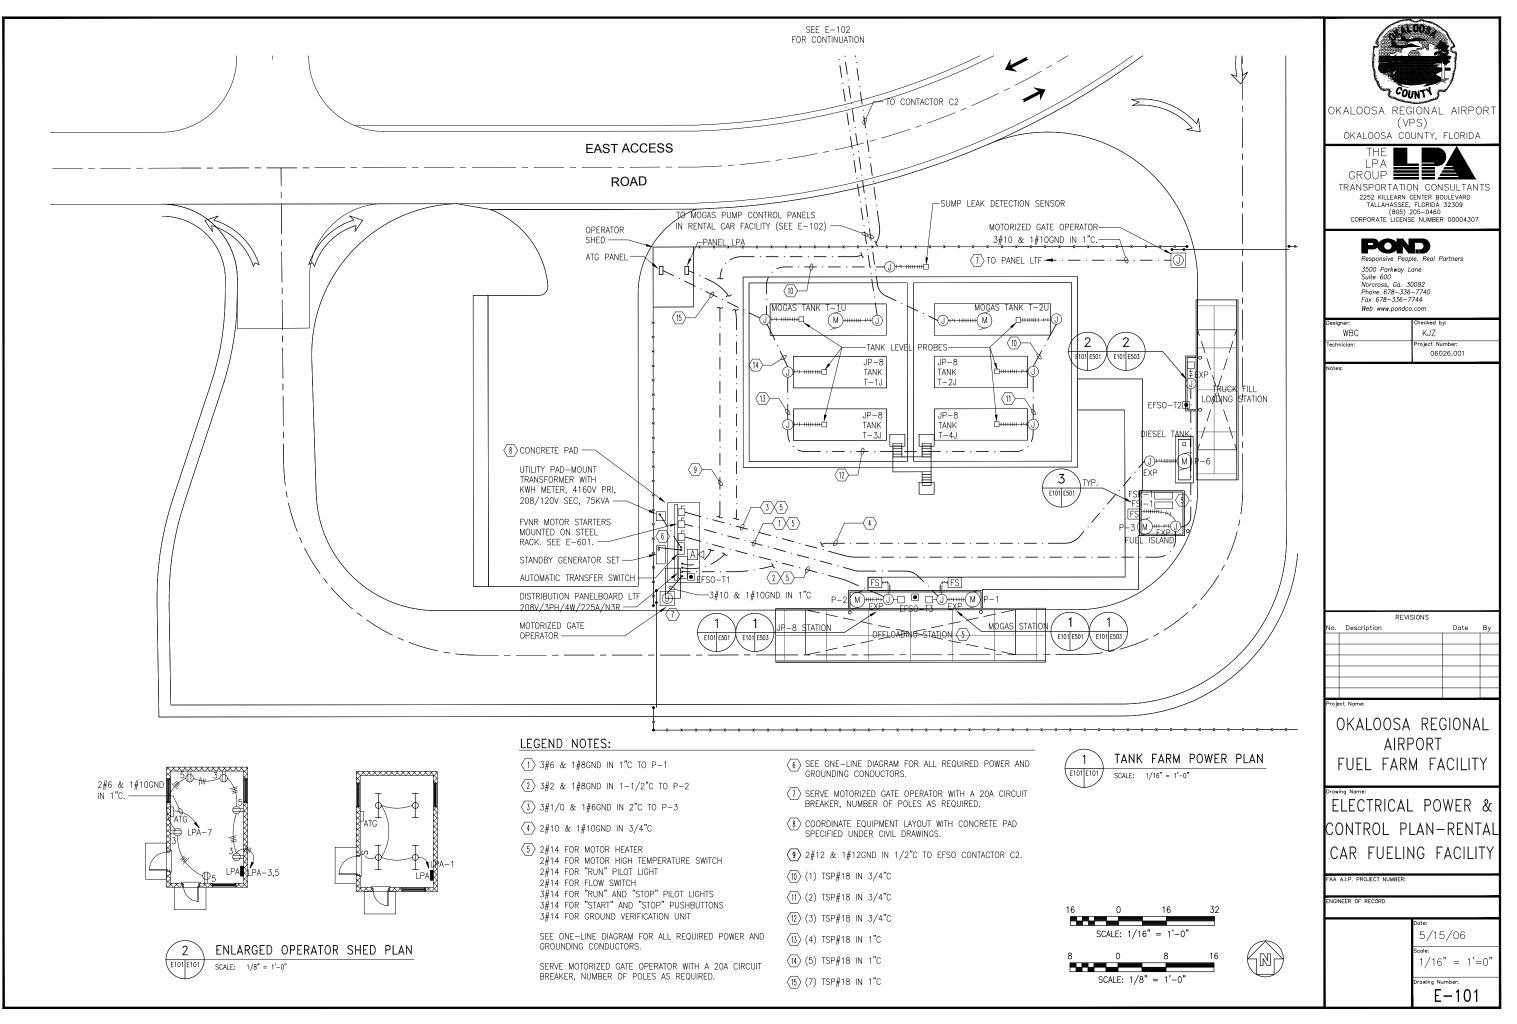

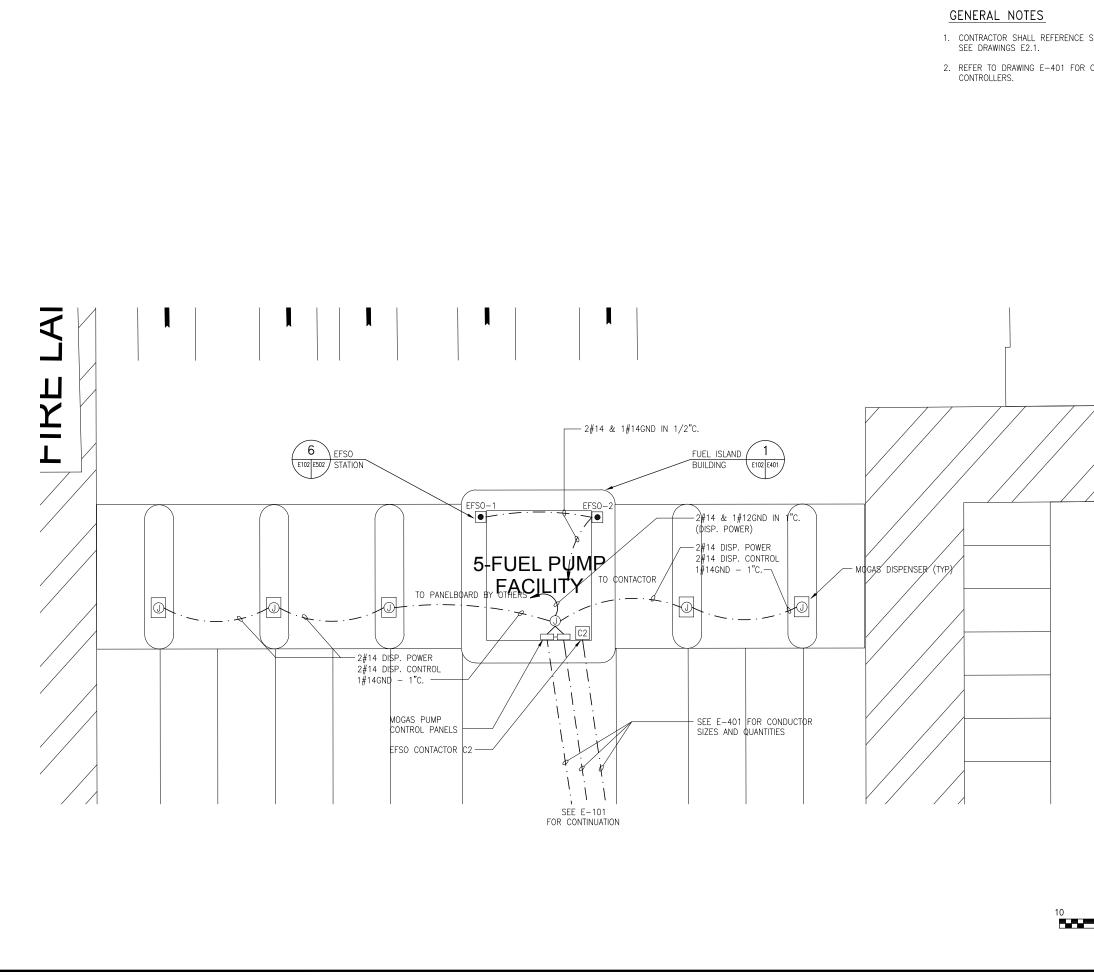



SPECIFICATIONS FOR FUEL MANAGEMENT SYSTEM. CONNECTION DETAILS ON MOGAS PUMP	OKALOOSA REGIONAL AIRPORT (VPS) OKALOOSA COUNTY, FLORIDA THE LPA GROUP TRANSPORTATION CONSULTANTS 2252 KILLEARN CENTER BOULEVARD TALLAHASSEE, FLORIDA 32009 (805) 205-0460 CORPORATE LICENSE NUMBER 00004307
	Responsive People. Real Partners 3500 Parkway Lane Suite 600 Norcross, Ga. 30092 Phone 678–336–7740 Fax 678–336–7744 Web www.pondco.com
	WBC KJZ
	Technician: Project Number: 06026.001
	REVISIONS No. Description Date By
	Project Norme: OKALOOSA REGIONAL AIRPORT FUEL FARM FACILITY
	ELECTRICAL POWER & CONTROL PLAN-RENTAL CAR FUELING FACILITY
	FAA A.I.P. PROJECT NUMBER:
	ENGINEER OF RECORD
0 10 20 SCALE: 1" = 10'	$\begin{array}{r} \text{Date:} \\ 5/15/06 \\ \hline \text{Scole:} \\ 1" = 10'-0" \\ \hline \text{Drawing Number:} \\ \hline E-102 \end{array}$

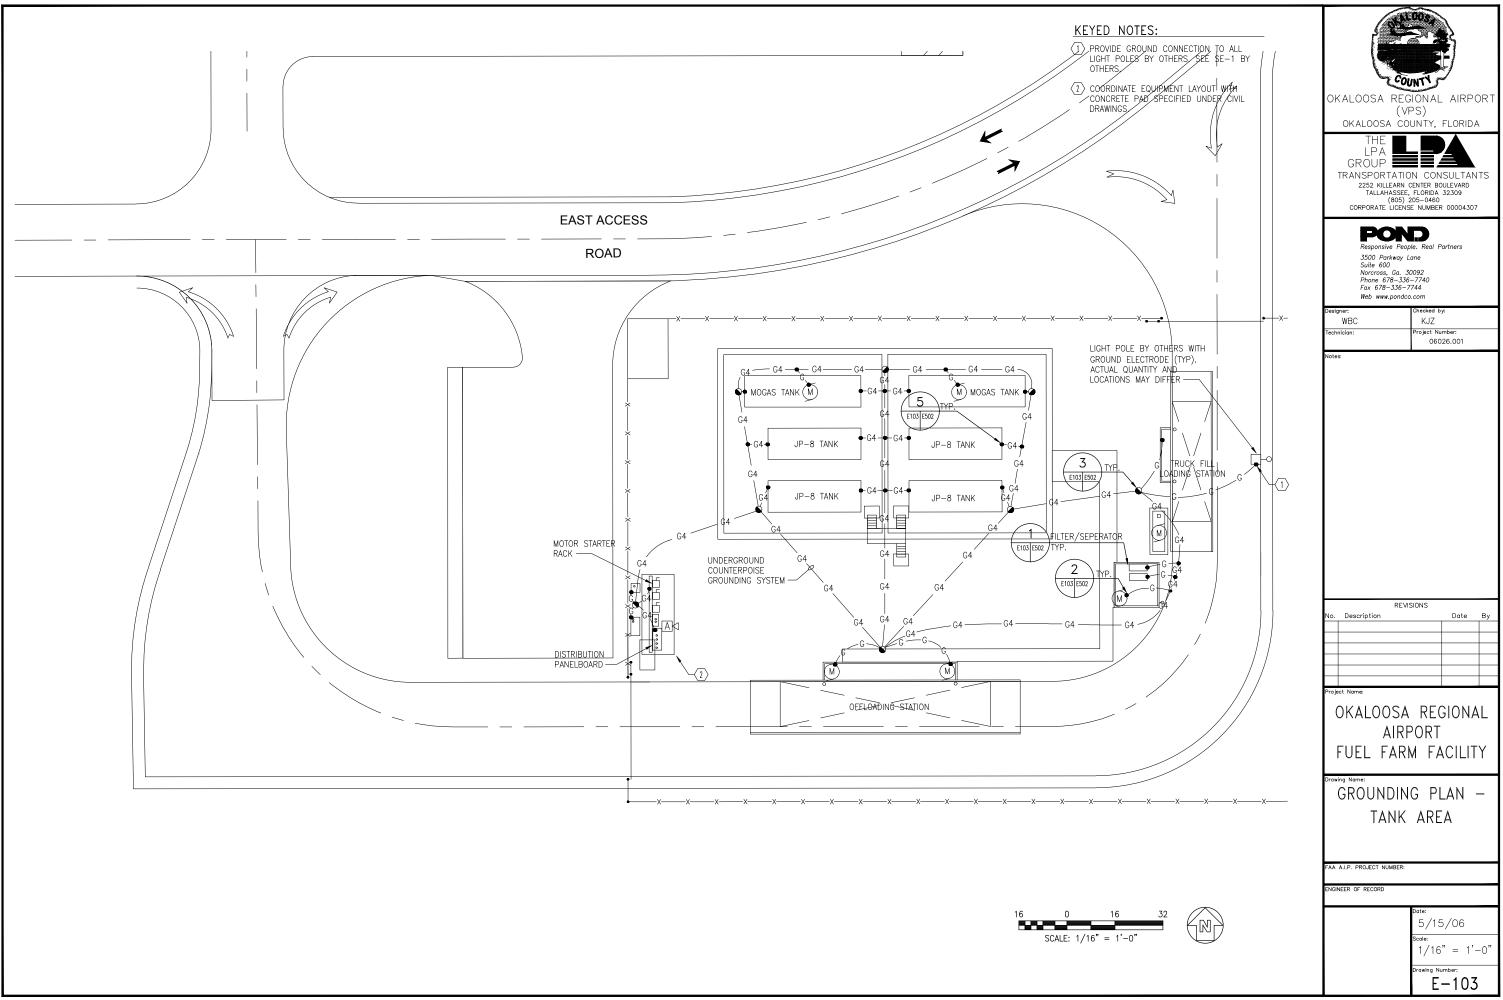


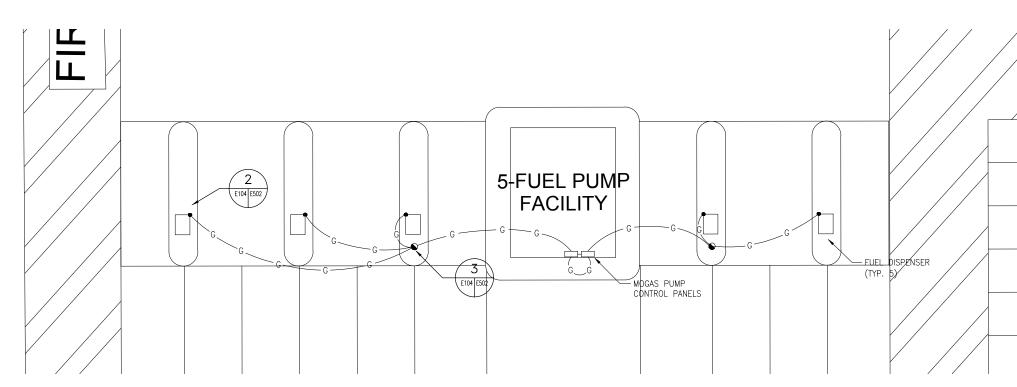


S

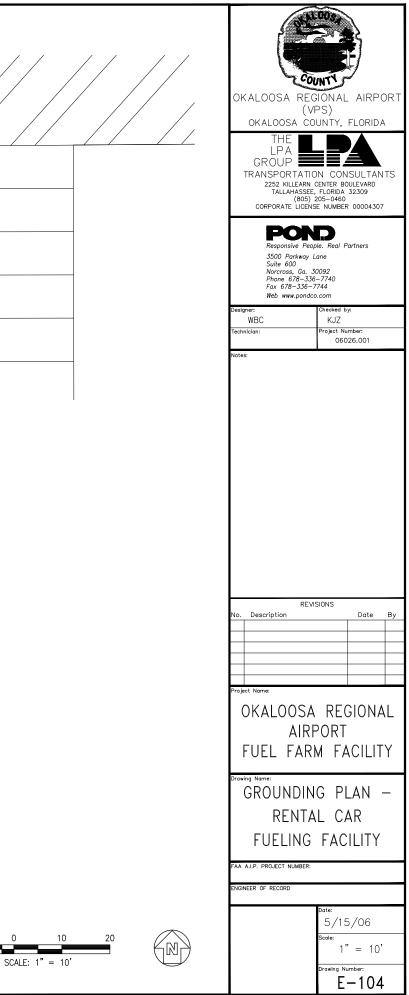


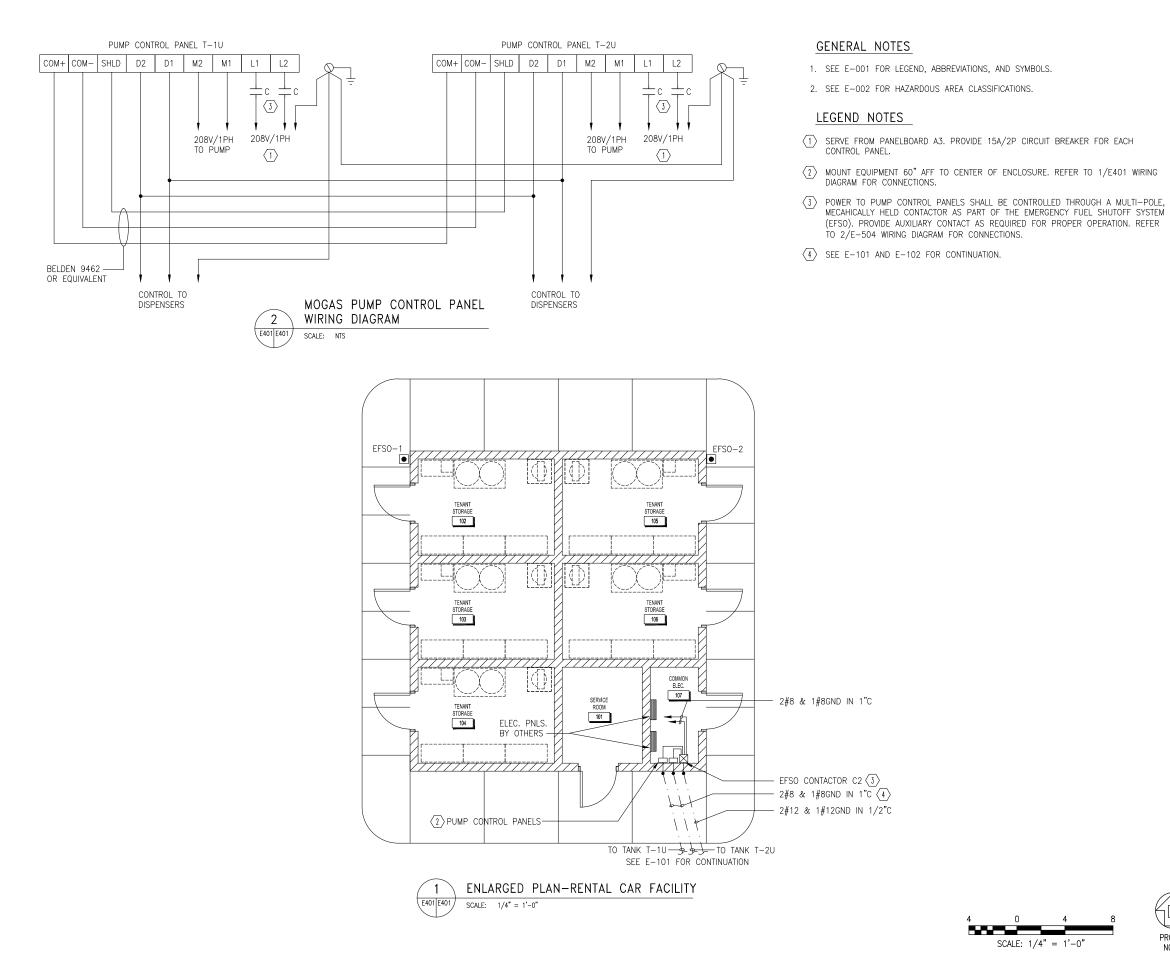

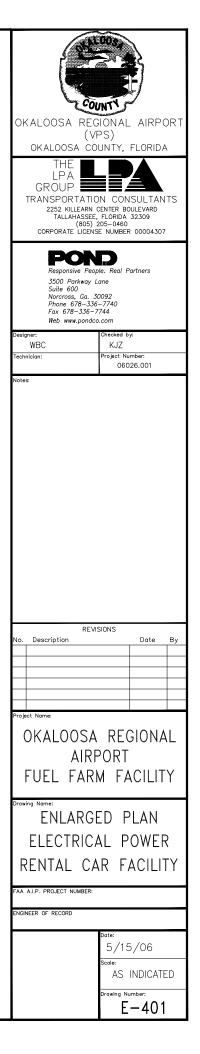




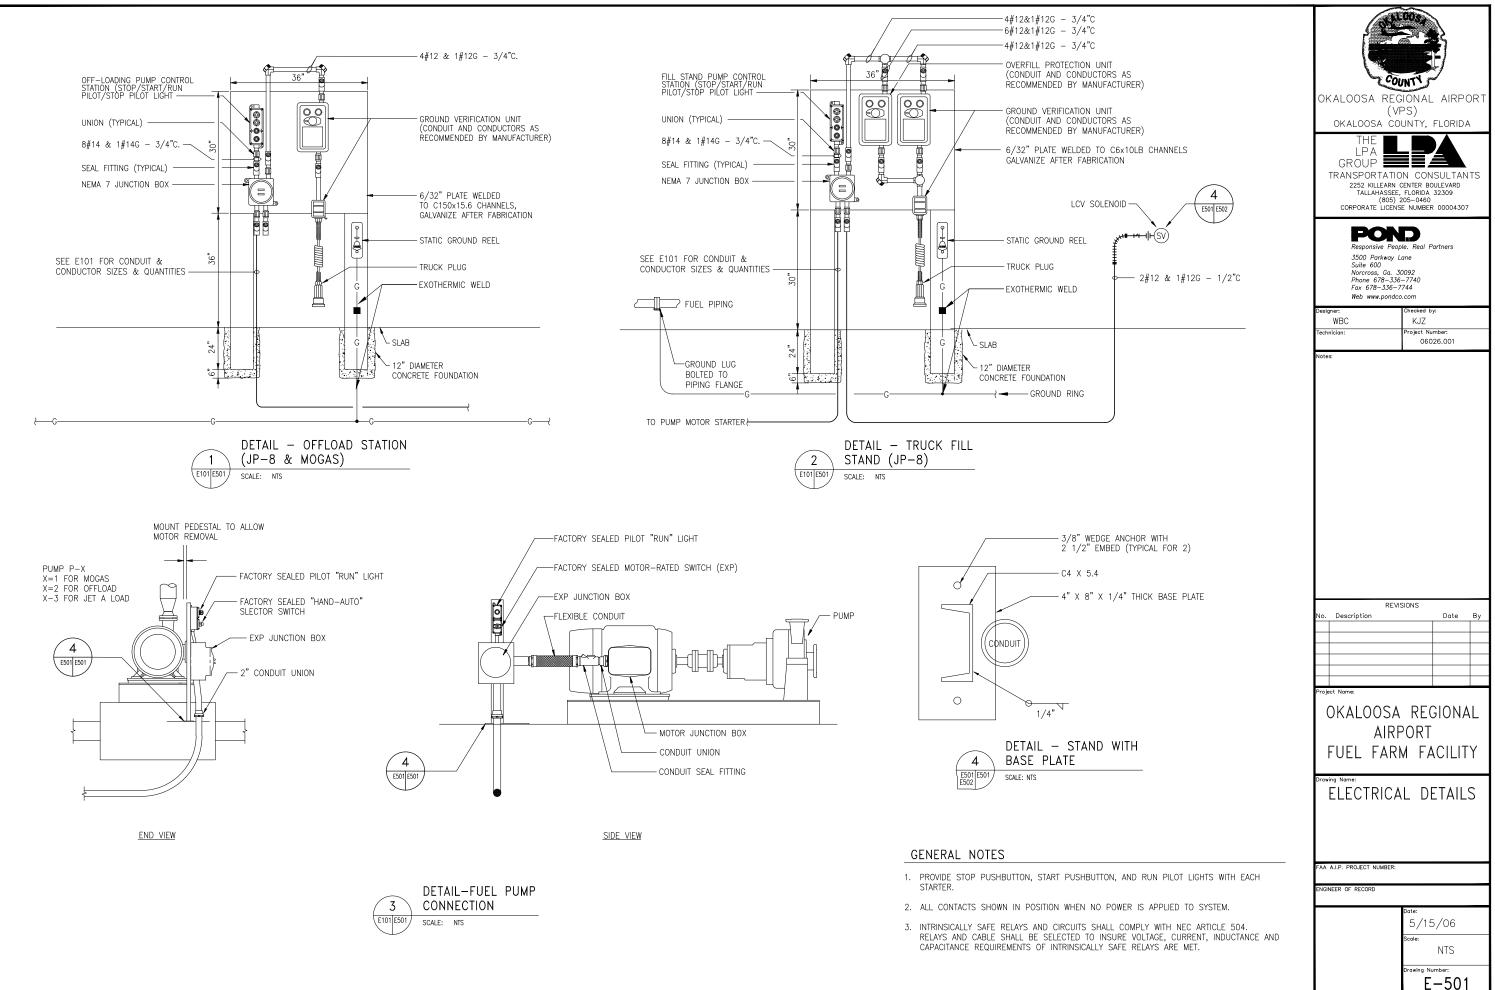


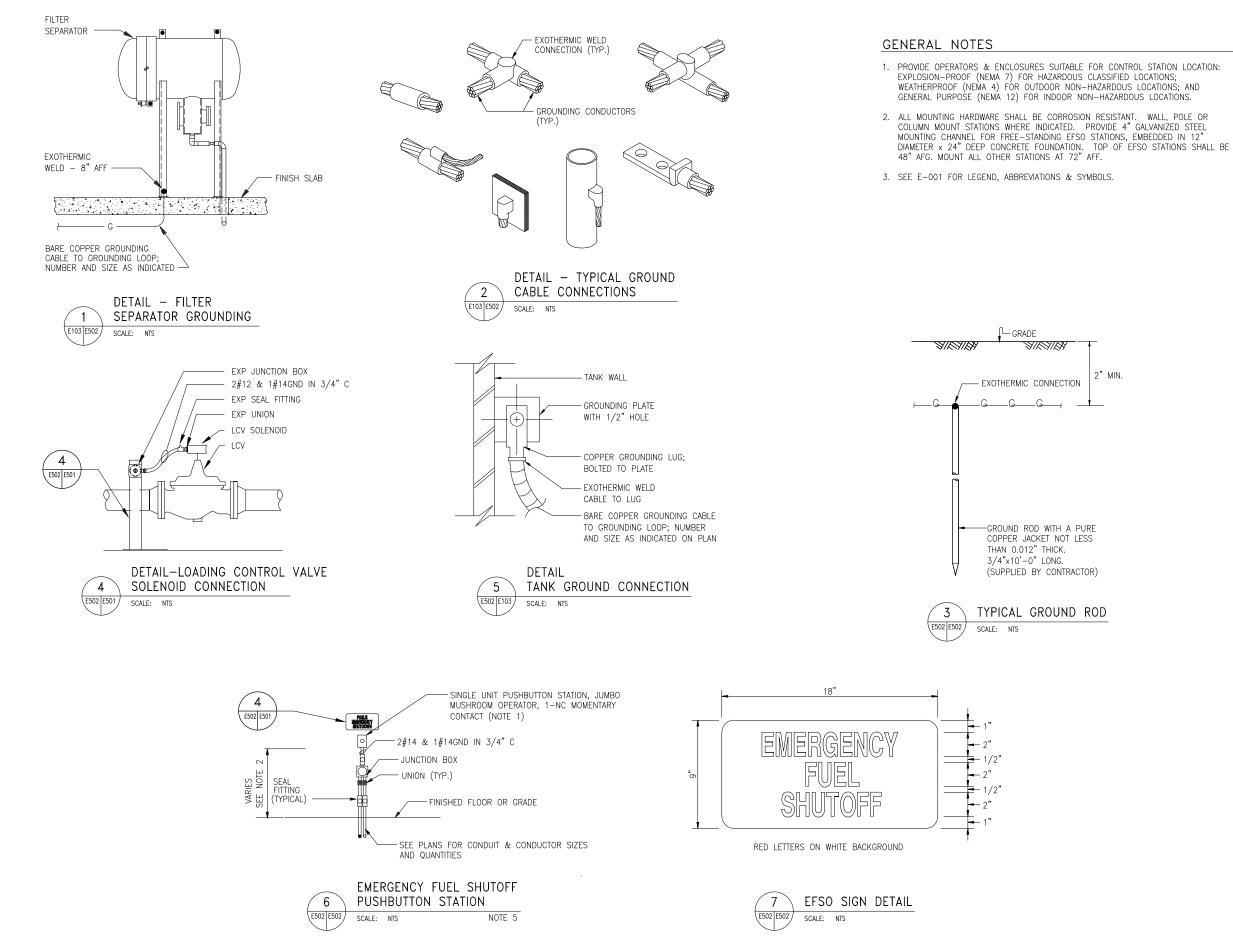

Marketing\Okaloosa\Fuel Farm\E502B.dwg January 24 2017 — 15:15

8 8 9 9 OUNT OKALOOSA REGIONAL AIRPORT (VPS) OKALOOSA COUNTY, FLORIDA LPA GROUP TRANSPORTATION CONSULTANTS 2252 KILLEARN CENTER BOULEVARD TALLAHASSEE, FLORIDA 32309 (805) 205-0460 CORPORATE LICENSE NUMBER 00004307 POND Responsive People. Real Partners 3500 Parkway Lane Suite 600 Norcross, Ga. 30092 Phone 678–336–7740 Fax 678–336–7744 Web www.pondco.com WBC KJZ roject Number: 06026.001 2" MIN. REVISIONS Description Date Bv roject Name OKALOOSA REGIONAL AIRPORT FUEL FARM FACILITY ELECTRICAL DETAILS AA A.I.P. PROJECT NUMBER NGINEER OF RECORD 5/15/06 cale NTS wing Number E-502

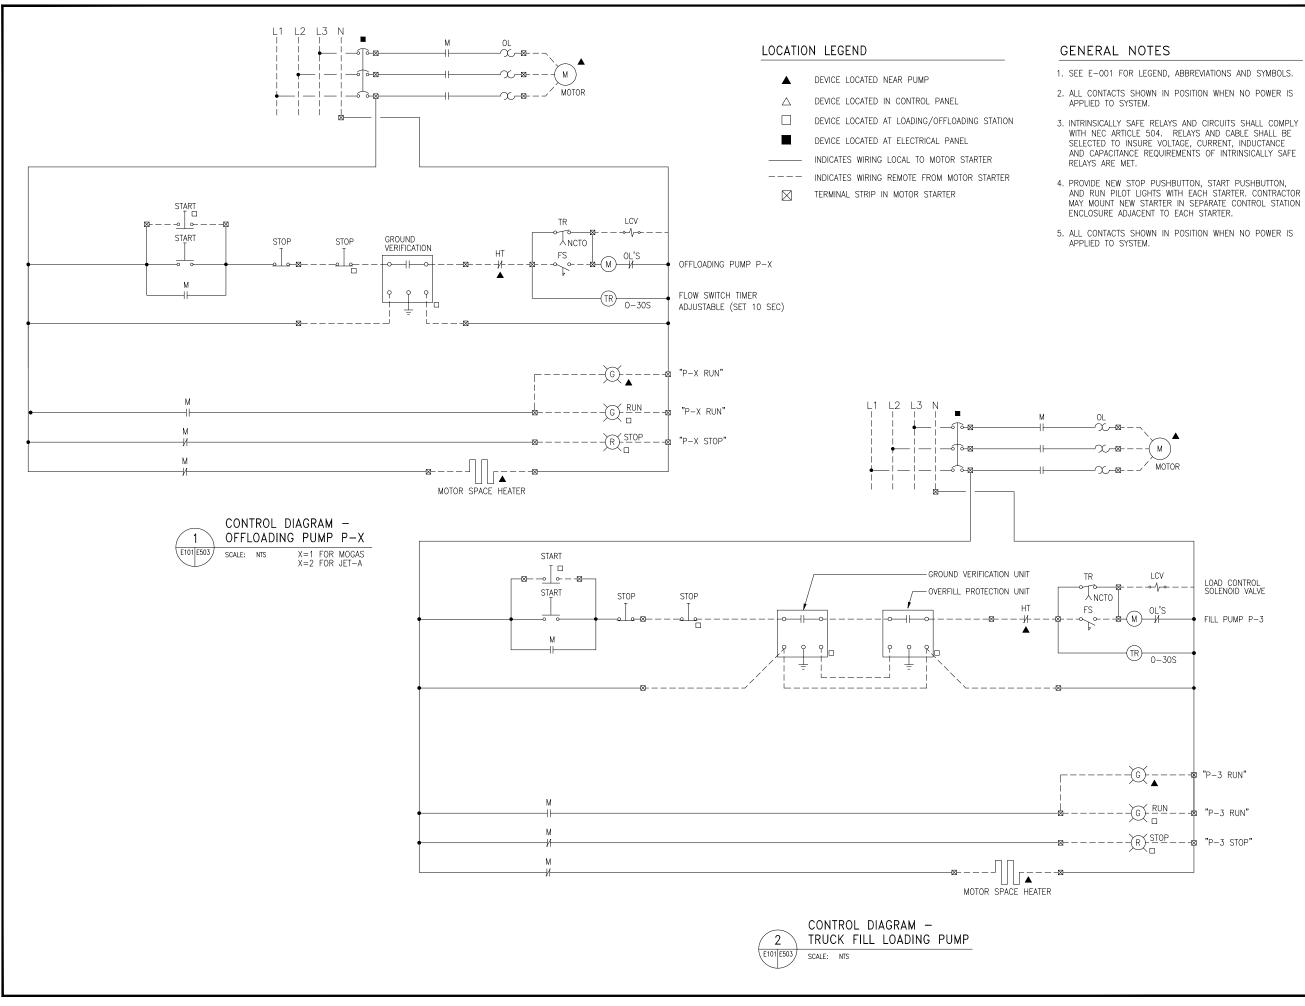

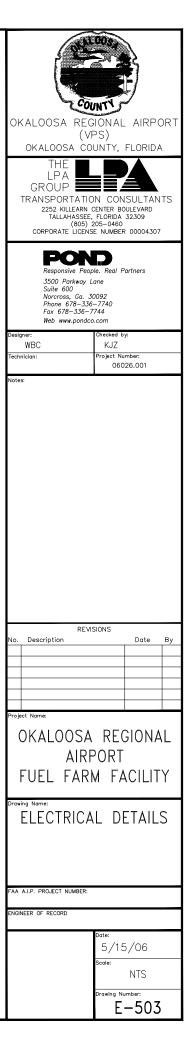



### GENERAL NOTES


- 1. SEE E-001 FOR LEGEND, ABBREVIATIONS AND SYMBOLS.
- 2. ALL CONTACTS SHOWN IN POSITION WHEN NO POWER IS APPLIED TO SYSTEM.
- 3. INTRINSICALLY SAFE RELAYS AND CIRCUITS SHALL COMPLY WITH NEC ARTICLE 504. RELAYS AND CABLE SHALL BE SELECTED TO INSURE VOLTAGE, CURRENT, INDUCTANCE AND CAPACITANCE REQUIREMENTS OF INTRINSICALLY SAFE RELAYS ARE MET.
- 4. ACTIVATION OF THE EFSO SYSTEM AT TANK FARM WILL ACTIVATE EFSO SYSTEM AT RENTAL CAR FACILITY. ACTIVATION OF THE EFSO SYSTEM AT THE RENTAL CAR FACILITY WILL NOT ACTIVATE THE EFSO SYSTEM AT THE TANK FARM.

## LOCATION LEGEND

- ▲ DEVICE LOCATED NEAR DISPENSER PUMP, RENTAL CAR FACILITY
- DEVICE LOCATED AT LOADING/OFFLOADING STATION, TANK FARM
- DEVICE LOCATED AT ELECTRICAL PANEL, TANK FARM
- INDICATES WIRING LOCAL TO RELAY CONTACTOR ENCLOSURE
- ---- INDICATES WIRING REMOTE FROM RELAY CONTACTOR ENCLOSURE
- TERMINAL STRIP IN RELAY CONTACTOR ENCLOSURE  $\boxtimes$

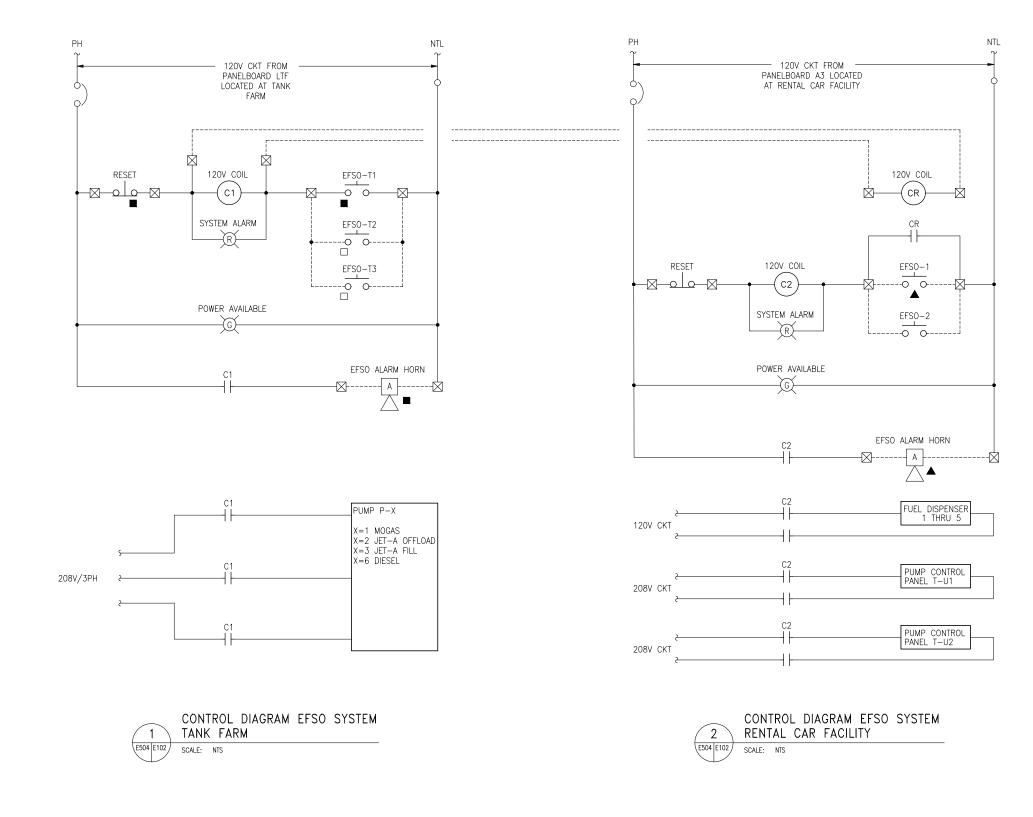

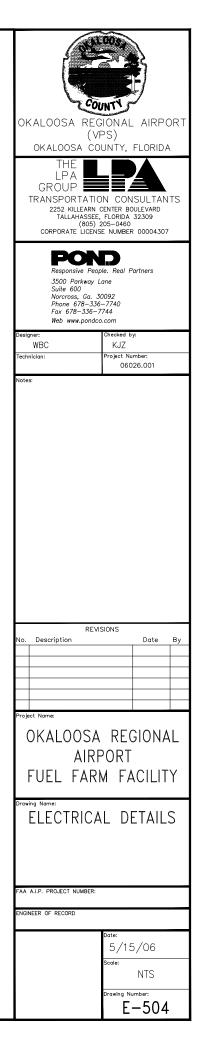


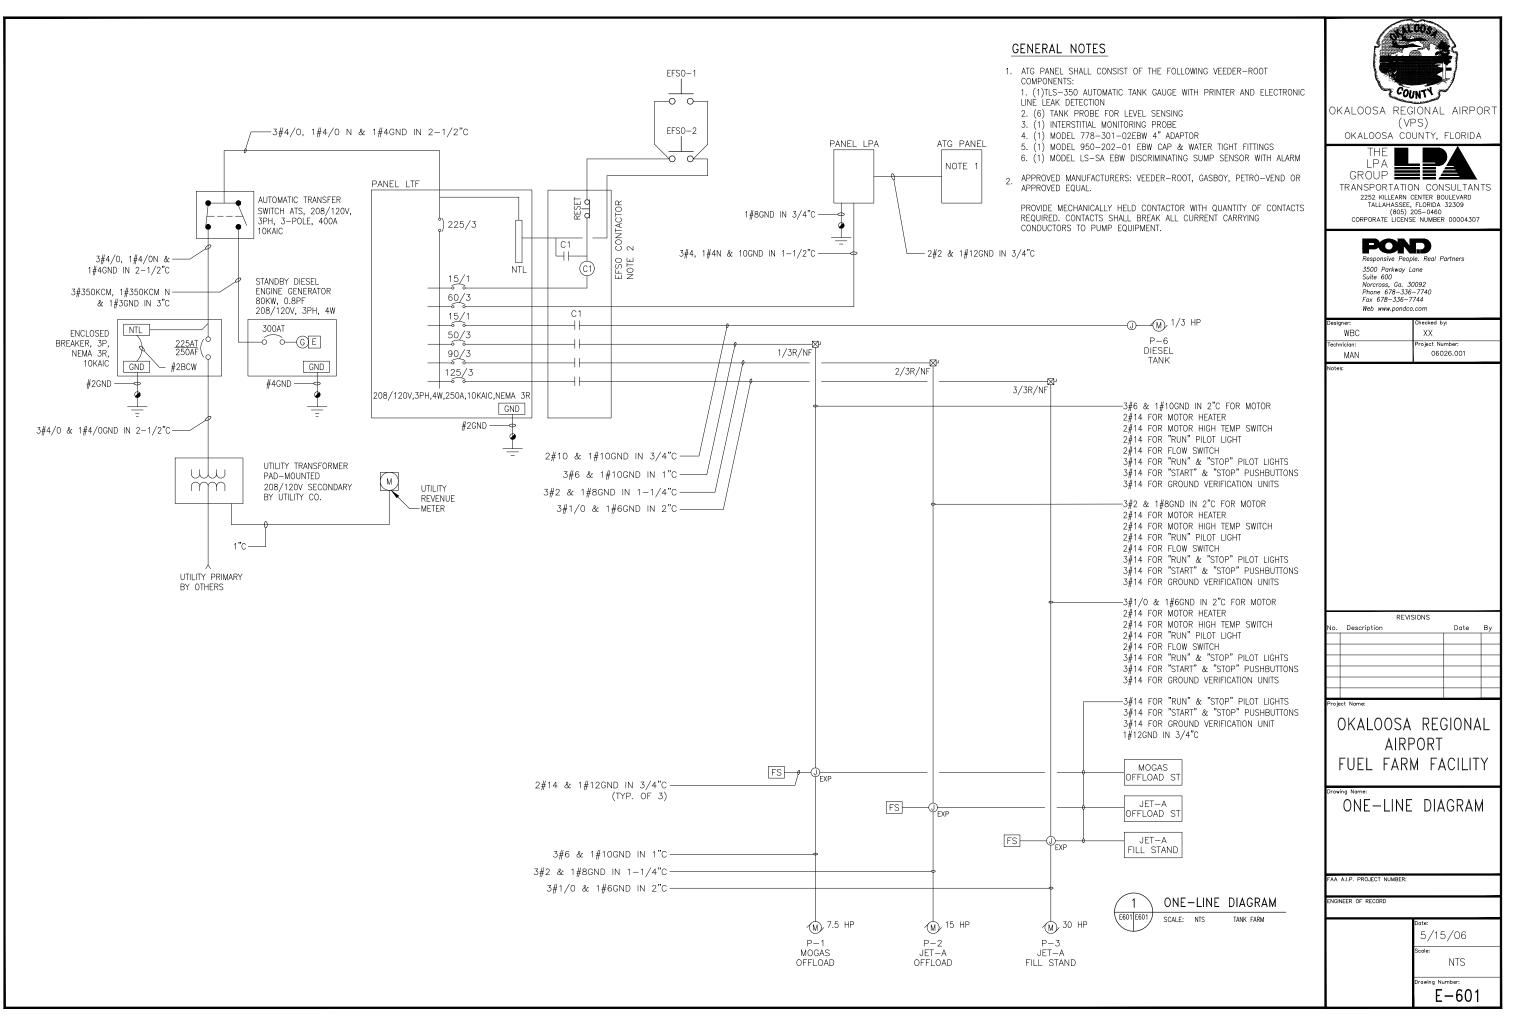

PANEL:		LTF	VOLTAGE: MAINS:			VOLT, 3PH, 4W CIRCUIT BREAK					
			MOUNTING:	SURF	ACE, NEMA	3R				MINIMUM A	IC RATING: 10 KA
DEVICE		BRANCH CIRCUIT				HASE LOAD (V	'A)			BRANCH CIRCUIT	DEVICE
AMP TRIP	POLES	DESIGNATION	CONN. VA	N0.	A	В	С	NO.	CONN. VA	DESIGNATION	POLES
				1	0	Х	Х	2		SPACE	
50	3	P-1 MOGAS	9100	3	Х	9100	Х	4		SPACE	
				5	Х	Х	0	6		SPACE	
				7	0	Х	Х	8		SPACE	
90	3	P-2 JP-8	17400	9	X	17400	Х	10		SPACE	
				11	Х	Х	0	12		SPACE	
				13	0	Х	Х	14		SPACE	
125	3	P-3 FILL STAND	33100	15	X	33100	Х	16		SPACE	
				17	Х	Х	0	18		SPACE	
				19	0	Х	Х	20		SPACE	
15	3	P-6 DIESEL TANK	900	21	Х	900	Х	22		SPACE	
				23	Х	Х	0	24		SPACE	
				25	0	Х	Х	26		SPACE	
	3	SPACE		27	Х	0	Х	28		SPACE	
				29	Х	Х	0	30		SPACE	
				31	0	Х	Х	32		SPACE	
	3	SPACE		33	X	0	Х	34		SPACE	
				35	Х	Х	0	36		SPACE	
				37	0	Х	X	38		SPACE	
	3	SPACE		39	X	0	Х	40		SPACE	
				41	Х	Х	0	42		SPACE	
		TOTAL CON	NECTED VA		0	60500	0				
						60500					

PAN	NEL:	LPA	VOLTAGE: MAINS:		208Y/120 \ 60 AMP MA	/OLT, 3PH, 4W IN BREAKER	I				
			MOUNTING:	SURF	ACE, NEMA 1					MINIMUM AIC	RATING: 10 KAI
DEVIC	CE	BRANCH CIRCUIT			PHASE LOAD (VA)					BRANCH CIRCUIT	DEVICE
	TDID	DESIGNATION	CONN. VA	NO.	A	В	с	N0.	CONN. VA	DESIGNATION	POLICE
	1	LIGHTS	260	1	6200	X	Ϋ́ Χ	2	5940	TWAC-1	POLES 2
1	1	RECEPTACLES	600	3	X	6540	X	4	5940	TWAC-1	2
1	1	RECEPTACLES	600	5	Х	X	600	6	0010		
1	1	ATG PANEL	500	7	500	Х	X	8			
				9	Х	0	Х	10			
				11	Х	Х	0	12			
		TOTAL CONNECTE	D VA		6700	6540	600				
		 				13840					
PANI NOTI		LPA									

				0034	
			200	UNTY	y
10 KA DEVICE		OKAL			. AIRPORT
		OK,	ALOOSA CO	PS) )UNTY,	FLORIDA
POLES	AMP TRIP	TRAN	THE LPA ROUP NSPORTATIO 2252 KILLEARN TALLAHASSEE (805) RPORATE LICEN	ON CON center bo , florida 205–0460	ULEVARD 32309
			Responsive Peo 3500 Parkway Suite 600 Norcross, Ga. 2 Phone 678–336– Yeb www.pondc	<b>D</b> ple. Real F Lane 80092 5-7740 7744	
		Designer: WBC		Checked b KJZ	y:
_		Technician:		Project Nu	mber: 26.001
		JCM Notes:		1 060	20.001
		1			
		1			
			PEV	ISIONS	
		No. Des	cription REV	1510115	Date By
10 KA	IC				
DEVICE	: 				
		Project Nam	ie:		
POLES 2	AMP TRIP 45	OK/	ALOOSA	RE(	GIONAL
			AIR		
		FUE	el far	M FA	CILITY
		Drawing Nar	ne:		
		(inter-	PANEL	BOA	RD
		1	SCHE		
		1	JUIL	JULL	
		FAA A.I.P. F	ROJECT NUMBER:		
		ENGINEER O	F RECORD		
		<u> </u>		Date:	
					5/06
					NTS
				Drawing Ni E	-602
		1		<u> </u>	

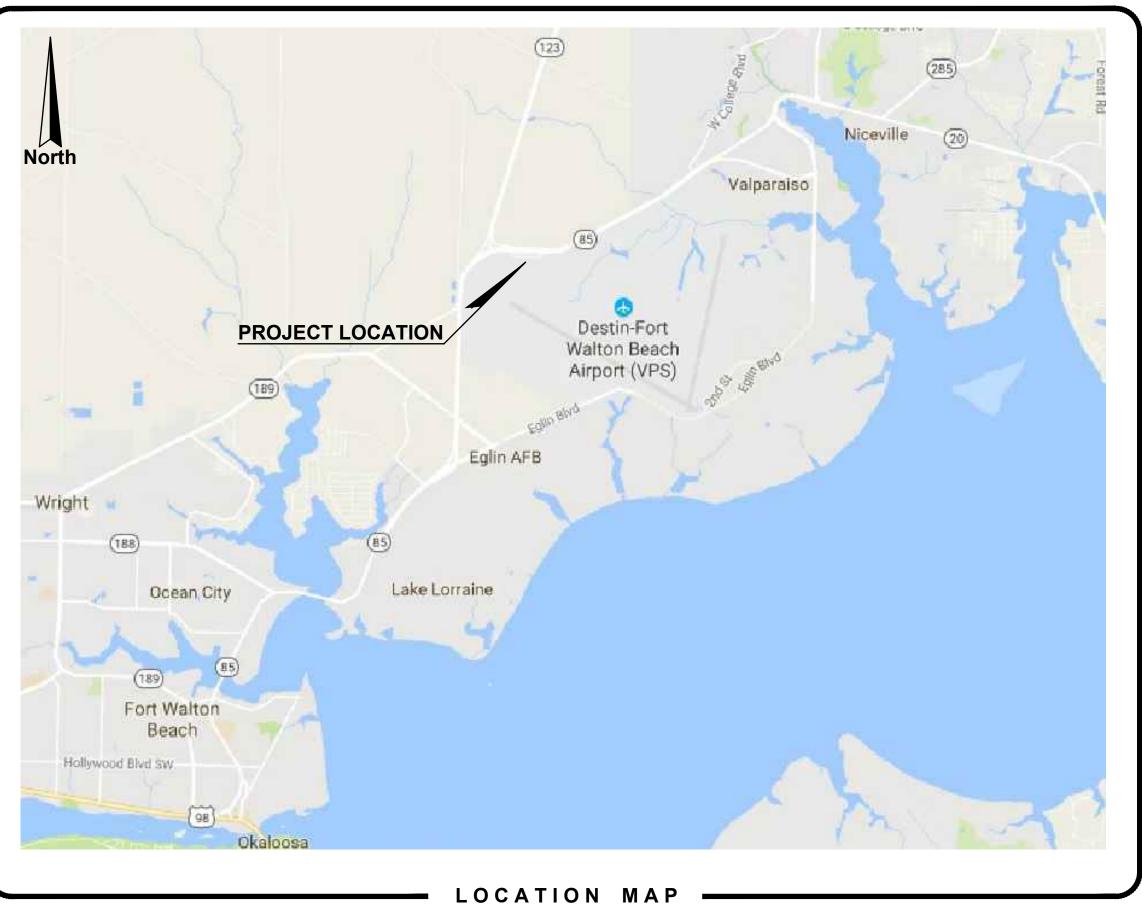



Airports Director: TRACY STAGE, A.A.E. Projects and GA Manager: CHAD ROGERS, P.E.

# **DESIGN DRAWINGS FOR:**

# **FUEL FARM EXPANSION**

# **DESTIN-FORT WALTON BEACH AIRPORT (VPS)** EGLIN AIR FORCE BASE, FLORIDA

### LOCATION MAP N.T.S.

	INDEX OF DRAWINGS						
SHEET NO.	SHEET TITLE	SHEET NO.	SHEET TITLE				
C-001	COVER SHEET	P-102	PUMP ISLAND ENLARGED PLAN - DEMOLITION				
C-002	GENERAL NOTES	P-103	PUMP ISLAND ENLARGED PLAN - NEW WORK				
C-003	CONTRACTOR ACCESS PLAN	P-104	JET A TANK SECTION 25,000 GAL. (TYPE 2)				
C-004	CIVIL SITE IMPROVEMENTS	P-105	DETAILS				
S-001	GENERAL NOTES	E-001	ELECTRICAL GENERAL NOTES AND LEGEND				
S-002	GENERAL NOTES	E-002	ELECTRICAL DETAILS				
S-100	NEW TANK FOUNDATION PLAN	E-003	HAZARDOUS LOCATION DETAILS & PANEL SCH.				
S-101	NEW PUMP ISLAND FOUNDATION PLAN	E-004	POWER RISER				
S-102	NEW WASTE TANK FOUNDATION PLAN	E-101	DEMOLITION ELECTRICAL SITE PLAN				
S-200	REINFORCED CONCRETE DETAILS	E-102	NEW WORK PARTIAL ELECTRICAL SITE PLAN				
S-201	PIPE SUPPORT STRUCTURAL DETAILS	E-103	NEW WORK PARTIAL ELECTRICAL SITE PLAN				
S-202	ACCESS LADDER STRUCTURAL DETAILS	E-104	NEW WORK ELECTRICAL GROUNDING PLAN				
P-101	MECHANICAL SITE PLAN						

# **RECORD DRAWINGS**

# **DRAWN BY:** CHECKED BY: **APPROVED BY:** DATE: PROJECT NO.

S.M.M J.R.C. V.C.L. FEBRUARY 2019 2017.050.02

REVISIONS						
NO.	DATE	DESCRIPTION	SHEETS			

# ENGINEERS



AVCON, INC. ENGINEERS & PLANNERS 320 BAYSHORE DRIVE, SUITE A - NICEVILLE, FL 32578-2425 OFFICE: (850) 678-0050 - FAX: (850) 678-0040 CORPORATE CERTIFICATE OF AUTHORIZATION NUMBER: 5057 www.avconinc.com

### **GENERAL NOTES:**

- CONTRACTOR SHALL PROTECT ALL EXISTING LANDSCAPING, SIDEWALKS, PAVEMENTS, CURBS, AND SOD NOT SPECIFIED FOR REMOVAL IN THESE PLANS. ANY DAMAGE TO THE EXISTING IMPROVEMENTS SHALL BE RESTORED BY THE CONTRACTOR AT NO COST TO THE OWNER. UNLESS OTHERWISE SPECIFIED HEREIN.
- 2. UNLESS OTHERWISE SPECIFIED, ALL WORK SHALL BE PERFORMED CONSISTENT WITH THE FOLLOWING SPECIFICATIONS: OKALOOSA COUNTY, FDOT, FAA, NWFWMD, AND FDEP.
- 3. THIS DESIGN HAS BEEN BASED UPON FIELD SURVEY BY NOBLES CONSULTING GROUP GEOTECHNICAL INFORMATION PROVIDED BY NOVA ENGINEERING AND ENVIRONMENTAL, LLC.
- AVCON INC. MAKES NO ASSURANCES REGARDING THE ACCURACY OF SUCH SURVEY OR GEOTECHNICAL EVALUATION.
- 4. CONTRACTOR SHALL FAMILIARIZE HIMSELF WITH THE SITE, INCLUDING ALL SURFACE AND SUB-SURFACE CONDITIONS, THE WORK REQUIRED AND ALL OTHER CONDITIONS THAT MAY AFFECT THE SUCCESSFUL COMPLETION OF THE JOB PRIOR TO COMMENCEMENT OF WORK.
- 5. THE CONTRACTOR SHALL GIVE ALL NOTICES AND COMPLY WITH ALL LAWS, ORDINANCES, RULES, REGULATIONS AND PERMIT CONDITIONS BEARING ON THE CONDUCT OF THE WORK, AS DRAWN AND SPECIFIED. IF THE CONTRACTOR OBSERVES THAT THE DRAWINGS AND SPECIFICATIONS ARE AT VARIANCE THEREWITH, HE SHALL PROMPTLY NOTIFY THE ENGINEER, IN WRITING, AND ANY NECESSARY CHANGES SHALL BE ADJUSTED, AS PROVIDED IN THE AGREEMENT FOR CHANGES IN THE WORK.
- 6. THE CONTRACTOR SHALL BE RESPONSIBLE TO THE OWNER AND THE ENGINEER FOR THE ACTS AND OMISSIONS OF CONTRACTOR'S EMPLOYEES AND ALL HIS SUBCONTRACTORS AND THEIR AGENTS AND EMPLOYEES AND OTHER PERSONS PERFORMING ANY OF THE WORK UNDER A CONTRACT WITH THE CONTRACTOR.
- 7. THE CONTRACTOR SHALL BE RESPONSIBLE FOR MAKING ALL NECESSARY ARRANGEMENTS WITH GOVERNMENTAL DEPARTMENTS, PUBLIC UTILITIES, PUBLIC CARRIERS, SERVICE COMPANIES, AND CORPORATIONS OWNING OR CONTROLLING ROADWAYS, RAILWAYS, WATER, SEWER, GAS, ELECTRICAL TELEPHONE. AND TELEGRAPH FACILITIES SUCH AS PAVEMENTS. TRACKS. PIPING. WIRES. CABLES. CONDUITS, POLES, GUYS, OR OTHER SIMILAR FACILITIES, INCLUDING INCIDENTAL STRUCTURES CONNECTED THEREWITH THAT ARE ENCOUNTERED IN THE WORK IN ORDER THAT SUCH ITEMS MAY BE PROPERLY SUPPORTED, PROTECTED OR LOCATED.
- 8. UNLESS OTHERWISE SPECIFIED IN THE GENERAL CONDITIONS, ALL CONSTRUCTION IS TO BE GOVERNED BY THE PLANS, APPLICABLE PERMITS, AND SPECIFICATIONS HEREIN, AND ALL APPLICABLE FEDERAL, STATE AND LOCAL BUILDING AND SAFETY CODES, LAWS AND ORDINANCES.
- PRIOR TO PERFORMING ANY WORK WITHIN ANY PUBLIC RIGHT-OF-WAY, CONTRACTOR SHALL DEVELOP AND IMPLEMENT A TRAFFIC CONTROL PLAN CONSISTENT WITH THE "MANUAL ON UNIFORM TRAFFIC CONTROL DEVICES" PUBLISHED BY THE U.S. DEPARTMENT OF TRANSPORTATION, FEDERAL HIGHWAY ADMINISTRATION.
- 10. IN THE EVENT THE CONTRACTOR DISCOVERS ANY ERRORS OR OMISSIONS IN THE PLANS HE SHALL IMMEDIATELY NOTIFY THE OWNER OR OWNER'S AGENT
- 11. CONTRACTOR SHALL PRESERVE AND PROTECT ALL PERMANENT REFERENCE MONUMENTS, PERMANENT CONTROL POINTS, PERMANENT BENCH MARKS AND PROPERTY CORNERS. IN THE EVENT THE MONUMENTS, POINTS OR MARKERS ARE DISTURBED THE CONTRACTOR SHALL EMPLOY A FLORIDA REGISTERED LAND SURVEYOR TO RESET OR REPLACE THEM.
- 12. THE OWNER, OWNER'S AGENT AND INSPECTORS OF APPLICABLE GOVERNMENT JURISDICTIONS, SHALL AT ALL TIMES HAVE ACCESS TO THE WORK WHEREVER AND WHENEVER IT IS IN PREPARATION OR PROGRESS; AND THE CONTRACTOR SHALL PROVIDE PROPER FACILITIES FOR SUCH ACCESS AND FOR THE INSPECTION.
- 13. IT IS THE CONTRACTOR'S RESPONSIBILITY TO TAKE ALL REASONABLE AND PRUDENT PRECAUTIONS TO INSURE THAT ALL COMPLETED WORK, MATERIALS AND EQUIPMENT STORED ON SITE ARE SAFE AND SECURED FROM UNAUTHORIZED ACCESS OR USE. SUCH PRECAUTIONS MAY INCLUDE INSTALLATION OF SIGNS, FENCES, OR POSTING OF SECURITY GUARDS.
- 14. CONTRACTOR SHALL, AT ALL TIMES, UTILIZE ALL NORMALLY ACCEPTED AND REASONABLY EXPECTED SAFETY PRACTICES AND COMPLY WITH ALL FEDERAL, STATE AND LOCAL REGULATIONS, ORDINANCES AND GUIDELINES PERTAINING TO SAFE UTILIZATION OF EQUIPMENT OR MATERIALS AS PUBLISHED BY MANUFACTURER.
- 15. PRIOR TO INITIATING ANY EXCAVATION (INCLUDING BUT NOT LIMITED TO TUNNELS, DITCHES, STORMWATER PONDS, CANALS, ARTIFICIAL LAKES) CONTRACTOR SHALL INSTALL FENCES AND TAKE ALL OTHER REASONABLE AND PRUDENT STEPS TO ENSURE THAT ACCESS TO EXCAVATION BY UNAUTHORIZED PERSONNEL IS PREVENTED.
- 16. THE CONTRACTOR SHALL TAKE ALL REASONABLE PRECAUTIONS FOR THE SAFETY OF, AND SHALL PROVIDE ALL REASONABLE PROTECTION TO PREVENT DAMAGE, INJURY OR LOSS TO:
- A. ALL EMPLOYEES ON THE WORK AND ALL OTHER PERSONS WHO MAY BE AFFECTED THEREBY:
- B. ALL THE WORK AND ALL MATERIALS AND EQUIPMENT TO BE INCORPORATED THEREIN, WHETHER IN STORAGE ON OR OFF THE SITE, UNDER THE CARE, CUSTODY OR CONTROL OF THE CONTRACTOR OR ANY OF ITS SUBCONTRACTORS; AND
- C. OTHER PROPERTY AT THE SITE OR ADJACENT THERETO, INCLUDING TREES, SHRUBS, LAWNS, WALKS, PAVEMENTS, ROADWAY, STRUCTURES AND UTILITIES NOT DESIGNATED FOR DEMOLITION IN THE COURSE OF CONSTRUCTION.
- D. CONTRACTOR SHALL MAINTAIN PUBLIC ACCESS ON AIRPORT ACCESS ROADS AT ALL TIMES.
- 17. THE CONTRACTOR SHALL COMPLY WITH ALL APPLICABLE SAFETY CODES AND WITH ALL APPLICABLE LAWS, ORDINANCES, RULES, REGULATIONS AND LAWFUL ORDERS OF ANY PUBLIC, QUASI PUBLIC OR OTHER AUTHORITY HAVING JURISDICTION FOR THE SAFETY OF PERSONS OR PROPERTY OR FOR THEIR PROTECTION AGAINST DAMAGE, INJURY OR LOSS, OR DESIGNED TO PROTECT THE ENVIRONMENT. THE CONTRACTOR SHALL ERECT AND MAINTAIN, AS REQUIRED BY EXISTING CONDITIONS AND PROGRESS OF THE WORK, ALL REASONABLE SAFEGUARDS FOR SAFETY AND PROTECTION, INCLUDING POSTING DANGER SIGNS AND OTHER WARNINGS AGAINST HAZARDS, PROMULGATING SAFETY REGULATIONS AND NOTIFYING OWNERS AND USERS OF ADJACENT UTILITIES OF THE EXISTENCE OF HAZARDS AND OF THE SAFETY **REGULATIONS.**
- 18. ALL DAMAGE OR LOSS TO ANY PROPERTY REFERRED TO IN CLAUSES 16.1(B) AND 16.1(C) CAUSED IN WHOLE OR IN PART BY THE CONTRACTOR, A SUBCONTRACTOR, OR BY ANYONE FOR WHOSE ACTS ANY OF THEM MAY BE LIABLE, SHALL BE REMEDIED BY THE CONTRACTOR, EXCEPT DAMAGE OR LOSS PROPERLY ATTRIBUTABLE SOLELY TO THE ACTS OR OMISSIONS OF THE OWNER, OR THE ENGINEER OR ANYONE EMPLOYED BY THEM, OR FOR WHOSE ACTS ANY OF THEM MAY BE LIABLE, AND NOT PROPERLY ATTRIBUTABLE IN WHOLE OR IN PART, TO THE FAULT OR NEGLIGENCE OF THE CONTRACTOR.

- PERSONS OR PROPERTY.
- SECTION.
- SPILL ON PERSONS OR PROPERTY.
- OWNER IN WRITING.
- DEFAULT OF THIS CONTRACT.

19. UNTIL FINAL ACCEPTANCE OF THE WORK BY OWNER, THE CONTRACTOR SHALL HAVE THE CHARGE AND CARE OF AND SHALL BEAR THE RISK OF INJURY OR DAMAGE. LOSS OR EXPENSE TO ANY PART THEREOF, OR TO ANY MATERIALS STORED ON SITE, BY THE ACTION OF THE ELEMENTS OR FROM ANY OTHER CAUSE WHETHER ARISING FROM THE EXECUTION OR NON-EXECUTION OF THE WORK. THE CONTRACTOR SHALL REBUILD, REPAIR, RESTORE AND MAKE GOOD ALL INJURIES OR DAMAGES TO ANY PORTION OF THE WORK OCCASIONED BY ANY OF THE ABOVE CAUSES BEFORE FINAL ACCEPTANCE AND SHALL BEAR THE EXPENSES THEREOF.

20. THOSE PARTS OF WORK IN PLACE WHICH ARE SUBJECT TO DAMAGE BECAUSE OF OPERATIONS BEING CARRIED ON ADJACENT THERETO SHALL BE COVERED, BOARDED UP OR SUBSTANTIALLY ENCLOSED WITH ADEQUATE PROTECTION BY THE CONTRACTOR AT CONTRACTOR'S EXPENSE.

21. PERMANENT OPENINGS USED AS THOROUGHFARES FOR THE INTRODUCTION OF WORK AND MATERIALS TO THE STRUCTURE SHALL HAVE HEADS, JAMBS AND SILLS WELL BLOCKED AND BOARDED BY THE CONTRACTOR. OWNER RETAINS THE AUTHORITY, BUT ASSUMES NO DUTY, TO ESTABLISH STANDARDS OF PROTECTION, AND TO REVIEW THE EFFICIENCY OF PROTECTIVE MEASURES TAKEN BY THE CONTRACTOR.

22. ADEQUATE TRAFFIC CONTROL, BARRICADES AND FLAGMAN SERVICES SHALL BE FURNISHED AND MAINTAINED BY THE CONTRACTOR AT ALL POINTS WHERE CONVEYING EQUIPMENT ENGAGED ON THE WORK REGULARLY ENTERS ONTO OR CROSSES TRAFFIC-CARRYING ROADS.

23. THE CONTRACTOR SHALL COMPLY IN EVERY RESPECT WITH THE FEDERAL OCCUPATIONAL HEALTH AND SAFETY ACT OF 1970 AND ALL RULES AND REGULATIONS NOW OR HEREAFTER IN EFFECT UNDER SAID ACT, AND THE CONTRACTOR FURTHER AGREES TO COMPLY WITH ANY AND ALL APPLICABLE STATE LAWS AND REGULATIONS PERTAINING TO JOB SAFETY AND HEALTH.

24. THE CONTRACTOR SHALL PROTECT AND KEEP OWNER (INCLUDING THEIR AGENTS AND EMPLOYEES) FREE AND HARMLESS FROM ANY AND ALL LIABILITY, PUBLIC OR PRIVATE, PENALTIES, CONTRACTUAL OR OTHERWISE, LOSSES, DAMAGES, COSTS, ATTORNEY'S FEES, EXPENSES, CAUSES OF ACTION, CLAIMS OR JUDGMENTS RESULTING FROM THE FEDERAL OCCUPATIONAL SAFETY AND HEALTH ACT OF 1970 AS AMENDED OR ANY RULE OR REGULATION PROMULGATED THEREUNDER OR OF ANY STATE LAWS OR REGULATIONS PERTAINING TO JOB SAFETY AND HEALTH ARISING OUT OF OR IN ANY WAY CONNECTED WITH THE PERFORMANCE OF WORK OR WORK TO BE PERFORMED UNDER THIS CONTRACT, AND CONTRACTOR SHALL INDEMNIFY OWNER FROM ANY SUCH CLAIMS, PENALTIES, SUITS OR ACTIONS, PUBLIC OR PRIVATE, ADMINISTRATIVE OR JUDICIAL, INCLUDING ATTORNEY'S FEES PAID OR INCURRED BY OR ON BEHALF OF OWNER, JOINTLY OR SEVERALLY, AND/OR THEIR AGENTS AND EMPLOYEES. THE CONTRACTOR FURTHER AGREES, IN THE EVENT OF A CLAIMED VIOLATION OF ANY FEDERAL OR STATE SAFETY AND HEALTH LAW OR REGULATION ARISING OUT OF OR IN ANY WAY CONNECTED WITH THE PERFORMANCE OF WORK OR WORK TO BE PERFORMED UNDER THIS CONTRACT, OWNER MAY IMMEDIATELY TAKE WHATEVER ACTION IS DEEMED NECESSARY BY OWNER TO REMEDY THE CLAIMED VIOLATION. ANY AND ALL COSTS OR EXPENSES PAID OR INCURRED BY OWNER IN TAKING SUCH ACTION SHALL BE BORNE BY CONTRACTOR, AND CONTRACTOR AGREES TO PROTECT, HOLD HARMLESS AND INDEMNIFY OWNER AGAINST ANY AND ALL SUCH COSTS OR EXPENSES.

25. ALL WORK PERFORMED UNDER THE CONTRACT, AND ALL EQUIPMENT, APPLIANCES, TOOLS AND LIKE ITEMS USED IN THE WORK SHALL CONFORM TO APPLICABLE SAFETY CODES AND REGULATIONS OF ANY PUBLIC OR OTHER AUTHORITY HAVING JURISDICTION. IN THE EVENT OF CONFLICTING REQUIREMENTS, THE MORE STRINGENT INTERPRETATION OR REGULATION SHALL GOVERN.

26. THE CONTRACTOR SHALL IMPLEMENT THE PROPOSED EROSION CONTROL PLAN TO MINIMIZE EROSION AND ENSURE FUNCTIONING OF STORMWATER MANAGEMENT SYSTEM DURING CONSTRUCTION. UPON COMPLETION OF CONSTRUCTION CONTRACTOR SHALL PROVIDE AS-BUILTS ENSURING THE STORMWATER MANAGEMENT SYSTEM IS OPERATING AS DESIGNED.

CONTRACTOR AND ITS SUBCONTRACTORS SHALL USE, HANDLE, TRANSPORT, AND DISPOSE OF ALL HAZARDOUS MATERIALS (AS DEFINED PARAGRAPH 20.8) IN COMPLIANCE WITH ALL PRESENT FEDERAL, STATE AND LOCAL ENVIRONMENTAL, HEALTH OR SAFETY LAW, INCLUDING, BUT NOT LIMITED TO, ALL SUCH STATUTES, REGULATIONS, RULES, ORDINANCES, CODES, AND RULES OF COMMON LAW

28. CONTRACTOR FURTHER AGREES THAT CONTRACTOR AND ITS SUBCONTRACTORS SHALL NOT CAUSE THE DISCHARGE, RELEASE OR DISPOSAL OF ANY HAZARDOUS MATERIAL CREATED BY ITS WORK ON OR ABOUT THE JOB SITE. IN THE EVENT OF ANY SPILL, RELEASE OR ANY OTHER REPORTABLE OCCURRENCE, CONTRACTOR SHALL NOTIFY THE APPROPRIATE GOVERNMENTAL AGENCY AND SHALL TAKE SUCH ACTION AS MAY BE NECESSARY TO MINIMIZE THE DELETERIOUS EFFECT OF SUCH SPILL ON

29. CONTRACTOR AND ITS SUBCONTRACTORS SHALL, UPON COMPLETION OF PERFORMANCE OF ALL DUTIES UNDER THIS CONTRACT, REMOVE ALL SUPPLIES, MATERIALS, AND WASTE CONTAINING AND HAZARDOUS MATERIAL FROM THE JOB SITE. CONTRACTOR SHALL BEAR FULL FINANCIAL RESPONSIBILITY, AS BETWEEN THE PARTIES OF THIS CONTRACT, FOR THE COMPLIANCE OF CONTRACTOR AND ITS SUBCONTRACTORS WITH THE PROVISIONS OF THIS PARAGRAPH 28.7.

30. CONTRACTOR AGREES TO INDEMNIFY, DEFEND, PROTECT AND HOLD THE OWNER HARMLESS FROM AND AGAINST ANY CLAIMS INCLUDING. WITHOUT LIMITATION. ACTUAL ATTORNEY'S FEES AND ANY COSTS OF INVESTIGATION, SOILS TESTING, GOVERNMENTAL APPROVALS, REMEDIATION AND CLEAN-UP ARISING OUT OF OR IN ANY WAY CONNECTED WITH THE FAILURE OF CONTRACTOR OR ITS SUBCONTRACTORS, OR THEIR AGENTS, EMPLOYEES, OFFICERS, OR REPRESENTATIVES, TO COMPLY WITH THE TERMS OF THIS

31. SHOULD CONTRACTOR OR ITS SUBCONTRACTORS DISCHARGE, RELEASE OR DISPOSE OF ANY HAZARDOUS MATERIAL ON OR ABOUT THE JOB SITE IN VIOLATION OF THIS PARAGRAPH, CONTRACTOR SHALL IMMEDIATELY SO INFORM OWNER IN WRITING. IN THE EVENT OF ANY SPILL, RELEASE OR ANY OTHER REPORTABLE OCCURRENCE. CONTRACTOR SHALL NOTIFY THE APPROPRIATE GOVERNMENTAL AGENCY AND SHALL TAKE SUCH ACTION AS MAY BE NECESSARY TO MINIMIZE THE DELETERIOUS EFFECT OF SUCH

32. IN THE EVENT CONTRACTOR OR ITS SUBCONTRACTORS ENCOUNTER ON THE PREMISES ANY PIPELINE, UNDERGROUND STORAGE TANK OR OTHER CONTAINER, OF ANY KIND, THAT MAY CONTAIN A HAZARDOUS MATERIAL, OR ENCOUNTER MATERIAL REASONABLY BELIEVED TO BE A HAZARDOUS MATERIAL, CONTRACTOR SHALL IMMEDIATELY STOP WORK IN THE AREA AFFECTED AND REPORT THE CONDITION TO

33. IF CONTRACTOR OR ITS SUBCONTRACTORS DO NOT COMPLY WITH THE HAZARDOUS MATERIAL REQUIREMENTS, OWNER MAY, BUT IS NOT OBLIGATED TO, GIVE WRITTEN NOTICE OF VIOLATION TO CONTRACTOR. SHOULD CONTRACTOR OR ITS SUBCONTRACTORS FAIL TO COMPLY WITH THE REQUIREMENTS OF THIS PARAGRAPH WITHIN TWENTY-FOUR (24) HOURS FROM THE TIME OWNER ISSUES SUCH WRITTEN NOTICE OF NONCOMPLIANCE OR WITHIN THE TIME OF AN ABATEMENT PERIOD SPECIFIED BY ANY GOVERNMENTAL AGENCY, WHICHEVER PERIOD IS SHORTER, CONTRACTOR SHALL BE IN MATERIAL

- 34. "HAZARDOUS MATERIAL" MEANS ANY SUBSTANCE: (A) THE PRESENCE OF WHICH REQUIRES INVESTIGATION OR REMEDIATION UNDER ANY PRESENT FEDERAL, STATE OR LOCAL STATUTE, REGULATION, ORDINANCE, RULE, CODE, ORDER, ACTION, POLICY OR COMMON LAW, OR (B) WHICH IS OR BECOMES DEFINED AS A "HAZARDOUS WASTE," "HAZARDOUS SUBSTANCE," POLLUTANT OR CONTAMINANT UNDER ANY PRESENT FEDERAL, STATE OR LOCAL STATUTE, REGULATION, RULE OR ORDINANCE OR AMENDMENTS THERETO INCLUDING, WITHOUT LIMITATION, THE COMPREHENSIVE ENVIRONMENTAL RESPONSE COMPENSATION AND LIABILITY ACT (42 U.S.C. SECTIONS 9601 ET SEQ.) AND/OR THE RESOURCE CONSERVATION AND RECOVERY ACT (42 U.S.C. SECTIONS 6901 ET SEQ.), OR (C) WHICH IS TOXIC, EXPLOSIVE, CORROSIVE FLAMMABLE, INFECTIOUS, RADIOACTIVE, CARCINOGENIC, MUTAGENIC, OR OTHERWISE HAZARDOUS AND IS REGULATED BY ANY GOVERNMENTAL AUTHORITY, AGENCY, DEPARTMENT, COMMISSION, BOARD, AGENCY OR INSTRUMENTALITY OF THE UNITED STATES, THE STATE IN WHICH THE PREMISES ARE LOCATED OR ANY POLITICAL SUBDIVISION THEREOF, OR (D) THE PRESENCE OF WHICH ON THE PREMISES CAUSES OR THREATENS TO CAUSE A NUISANCE UPON THE PREMISES OR TO ADJACENT PROPERTIES OR POSES OR THREATENS TO POSE A HAZARD TO THE HEALTH OR SAFETY OF PERSONS ON OR ABOUT THE PREMISES, OR (E) WHICH CONTAINS GASOLINE, DIESEL FUEL OR OTHER PETROLEUM HYDROCARBONS. OR (F) WHICH CONTAINS POLYCHLORINATED BIPHENYL (PCBS), ASBESTOS, LEAD OR UREA FORMALDEHYDE FOAM INSULATION.
- 35. THE EXISTING UTILITIES SHOWN ARE APPROXIMATE. THE CONTRACTOR SHALL FIELD LOCATE ALL EXISTING UTILITIES AS TO SIZE, LOCATION, AND ELEVATION. THE CONTRACTOR SHALL NOTIFY THE ENGINEER OF ANY AND ALL CONFLICTS PRIOR TO BEGINNING CONSTRUCTION.
- 36. IF ANY TESTING, INSPECTION OR APPROVAL REVEAL DEFECTIVE WORK, CONTRACTOR SHALL NOT BE ALLOWED TO RECEIVE ANY ASSOCIATED COSTS AND THE OWNER SHALL BE ENTITLED TO DEDUCT FROM THE CONTRACT PRICE, BY ISSUING A CHANGE ORDER, OWNER'S COSTS ARISING OUT OF THE DEFECTIVE WORK, INCLUDING COSTS OF REPEATED PROCEDURES, COMPENSATION FOR ENGINEER'S AND DESIGN ENGINEER'S SERVICES AND OTHER RELATED COSTS.

### **SECURITY NOTES:**

- GENERAL THE CONTRACTOR SHALL COMPLY WITH ALL SECURITY REQUIREMENTS SPECIFIED IN THE CONTRACT MANUAL. THE CONTRACTOR SHALL DESIGNATE IN WRITING TO THE FIELD REPRESENTATIVE, THE NAME OF THE "CONTRACTOR SECURITY OFFICER". THE CONTRACTOR SECURITY OFFICER SHALL REPRESENT THE CONTRACTOR ON THE SECURITY REQUIREMENTS OF THE CONTRACT.
- 2. CONSTRUCTION SECURITY COMMITTEE A COMMITTEE SHALL BE ESTABLISHED CONCURRENT WITH THE LIFE OF THIS CONTRACT TO MONITOR AND COORDINATE SECURITY PROVISIONS, ADOPT NEW SECURITY PROVISIONS IF REQUIRED AND REVIEW AND APPROVE ALL MATTERS OF AIRPORT SECURITY RELATING TO THIS CONTRACT. MEETINGS SHALL BE SCHEDULED BY THE FIELD REPRESENTATIVE. COMMITTEE MEMBERSHIP SHALL INCLUDE THE CONTRACTOR SECURITY OFFICER, FIELD REPRESENTATIVE AND AIRPORT OPERATIONS.
- 3. CONTRACTOR PERSONNEL SECURITY ORIENTATION THE CONTRACTOR SECURITY OFFICER SHALL BE RESPONSIBLE FOR BRIEFING ALL CONTRACTOR PERSONNEL ON THESE REQUIREMENTS AND, FROM TIME TO TIME, OTHER SECURITY PROVISIONS ADOPTED BY THE CONSTRUCTION SECURITY COMMITTEE. ALL NEW CONTRACTOR EMPLOYEES SHALL BE BRIEFED ON THESE REQUIREMENTS PRIOR TO WORKING IN THE CONSTRUCTION AREA.
- 4. ACCESS TO THE SITE CONTRACTOR'S ACCESS TO THE SITE SHALL BE AS SHOWN ON THE PLANS OR AS DIRECTED BY THE FIELD REPRESENTATIVE. THE CONTRACTOR SHALL NOT PERMIT ANY UNAUTHORIZED PERSONNEL OR TRAFFIC ON THE SITE. THE CONTRACTOR SHALL BE RESPONSIBLE FOR TRAFFIC CONTROL TO AND FROM THE VARIOUS CONSTRUCTION AREAS ON THE SITE. THE CONTRACTOR IS RESPONSIBLE FOR THE IMMEDIATE CLEANUP OF ANY DEBRIS DEPOSITED ALONG ANY ACCESS ROAD AS A RESULT OF THE CONSTRUCTION TRAFFIC. DIRECTIONAL SIGNING AT THE ACCESS GATE AND ALONG THE DELIVERY ROUTE TO THE STORAGE AREA OR WORK SITE SHALL NOT BE PERMITTED.
- 5. MATERIALS DELIVERY TO THE SITE ALL CONTRACTOR'S MATERIAL ORDERS FOR DELIVERY TO THE SITE WILL USE THE ACCESS POINT AT THE CONTRACTOR'S STAGING AREA AS A DELIVERY ADDRESS AT THE AIRPORT. ALL ASSOCIATED COSTS SHALL BE INCIDENTAL TO VARIOUS OTHER BID ITEMS.
- 6. CONSTRUCTION AREA LIMITS THE LIMITS OF CONSTRUCTION, MATERIAL STORAGE AREAS, EQUIPMENT STORAGE AREA, PARKING AREA AND OTHER AREAS REQUIRED FOR THE CONTRACTOR'S EXCLUSIVE USE DURING CONSTRUCTION SHALL BE MARKED BY THE CONTRACTOR AND APPROVED BY THE FIELD REPRESENTATIVE. THE CONTRACTOR SHALL ERECT AND MAINTAIN SUITABLE FENCING, SIGNAGE AND WARNING DEVICES VISIBLE FOR BOTH DAY/NIGHT USE TO DELINEATE THE PERIMETER OF ALL SUCH AREAS.
- 7. VEHICLE IDENTIFICATION THE CONTRACTOR, THROUGH THE CONTRACTOR SECURITY OFFICER, SHALL ESTABLISH AND MAINTAIN A LIST OF CONTRACTOR AND SUBCONTRACTOR VEHICLES AUTHORIZED TO OPERATE ON THE SITE. THE CONTRACTOR SECURITY OFFICER WILL REQUIRE EACH VEHICLE TO DISPLAY A LARGE COMPANY SIGN (WITH NOT LESS THAN 6" LETTERING) ON BOTH SIDES OF VEHICLE. THE CONTRACTOR SHALL PROVIDE A CURRENT LISTING OF VEHICLES AND COMPANIES AUTHORIZED TO ENTER AND CONDUCT WORK ON THE AIRPORT TO THE FIELD REPRESENTATIVE. CONTRACTOR'S EMPLOYEE PERSONAL VEHICLES SHALL BE RESTRICTED TO THE CONTRACTOR'S STAGING AREA OR CONTRACTOR'S EMPLOYEE PARKING AREA AND ARE NOT ALLOWED ON THE AIRFIELD AT ANY TIME.
- 8. OPERATORS OF VEHICLES MUST POSSESS A VALID DRIVER'S LICENSE. FOR THE VEHICLE BEING OPERATED. CONTRACTOR SHALL BE RESPONSIBLE FOR ALL EMPLOYEES DRIVING WITHIN THE AOA, AND SHALL LIMIT EMPLOYEE ACCESS TO RUNWAY AND TAXIWAY OBJECT FREE AREAS TO THOSE WHOSE FUNCTIONS ARE ABSOLUTELY NECESSARY. DRIVERS SHALL MONITOR BOB SIKES AIRPORT UNICOM FREQUENCY AT ALL TIMES WHEN DRIVING WITHIN ANY RUNWAY OR TAXIWAY OBJECT FREE AREA. AND SHALL BE PREPARED TO LEAVE THE AREA IMMEDIATELY IF NECESSARY.
- 9. THE COST OF PROVIDING FLAGGER AND SECURITY GUARDS SHALL BE INCIDENTAL AND INCLUDED IN THE VARIOUS CONTRACT ITEMS.
- 10. OPEN FLAME OPEN FLAME, WELDING OR TORCH-CUTTING OPERATIONS ARE PROHIBITED UNLESS ADEQUATE FIRE AND SAFETY PRECAUTIONS HAVE BEEN TAKEN AND THE PROCEDURE APPROVED BY AIRPORT OPERATIONS.
- 11. NO SMOKING SHALL BE ALLOWED WITHIN THE WORK AREA.
- 12. SAFETY GUIDELINES IN THE INTEREST OF SAFETY, THE CONTRACTOR IS ALSO DIRECTED TO ACQUAINT HIS/HER EMPLOYEES WITH THE PROVISIONS OF THE FOLLOWING FEDERAL AVIATION ADMINISTRATION ADVISORY CIRCULARS:

150/5370–2E 150/5210–5C 150/5200–18C	_ _ _	OPERATIONAL SAFETY ON AIRPORTS PAINTING, MARKING AND LIGHTING OF AIRPORT SAFETY SELF-INSPECTION
150/5340-1J	-	STANDARDS FOR AIRPORT MARKINGS
ORDER SW 5200.5	-	SAFETY REQUIREMENTS ON AIRPORTS ACTIVITY

13. NO EQUIPMENT OR MATERIALS SHALL EXCEED A HEIGHT OF 35 FT WITHOUT PRIOR APPROVAL FROM ENGINEER.

DURING CONSTRUCTION. OF VEHICLES USED ON AN AIRPORT

TS DURING AGENCY FUNDED CONSTRUCTION







#### AVCON, INC. **ENGINEERS & PLANNERS**

320 BAYSHORE DRIVE, SUITE A - NICEVILLE, FL 32578-2425 OFFICE: (850) 678-0050 - FAX: (850) 678-0040 CORPORATE CERTIFICATE OF AUTHORIZATION NUMBER: 5057 www.avconinc.com

ENGINEER OF RECORD:

NAME: JOHN R. COLLINS, P.E. FL LICENSE NO.: 75419

AVCON, INC. 320 BAYSHORE DRIVE, SUITE A NICEVILLE, FL 32578 PHONE: (850) 678-0050 FAX: (850) 678-0040

FBPR CERTIFICATE OF AUTHORIZATION NO. 5057

# **DESTIN-FORT** WALTON BEACH AIRPORT

# FUEL FARM EXPANSION

### **GENERAL NOTES**

#### ATTENTION:

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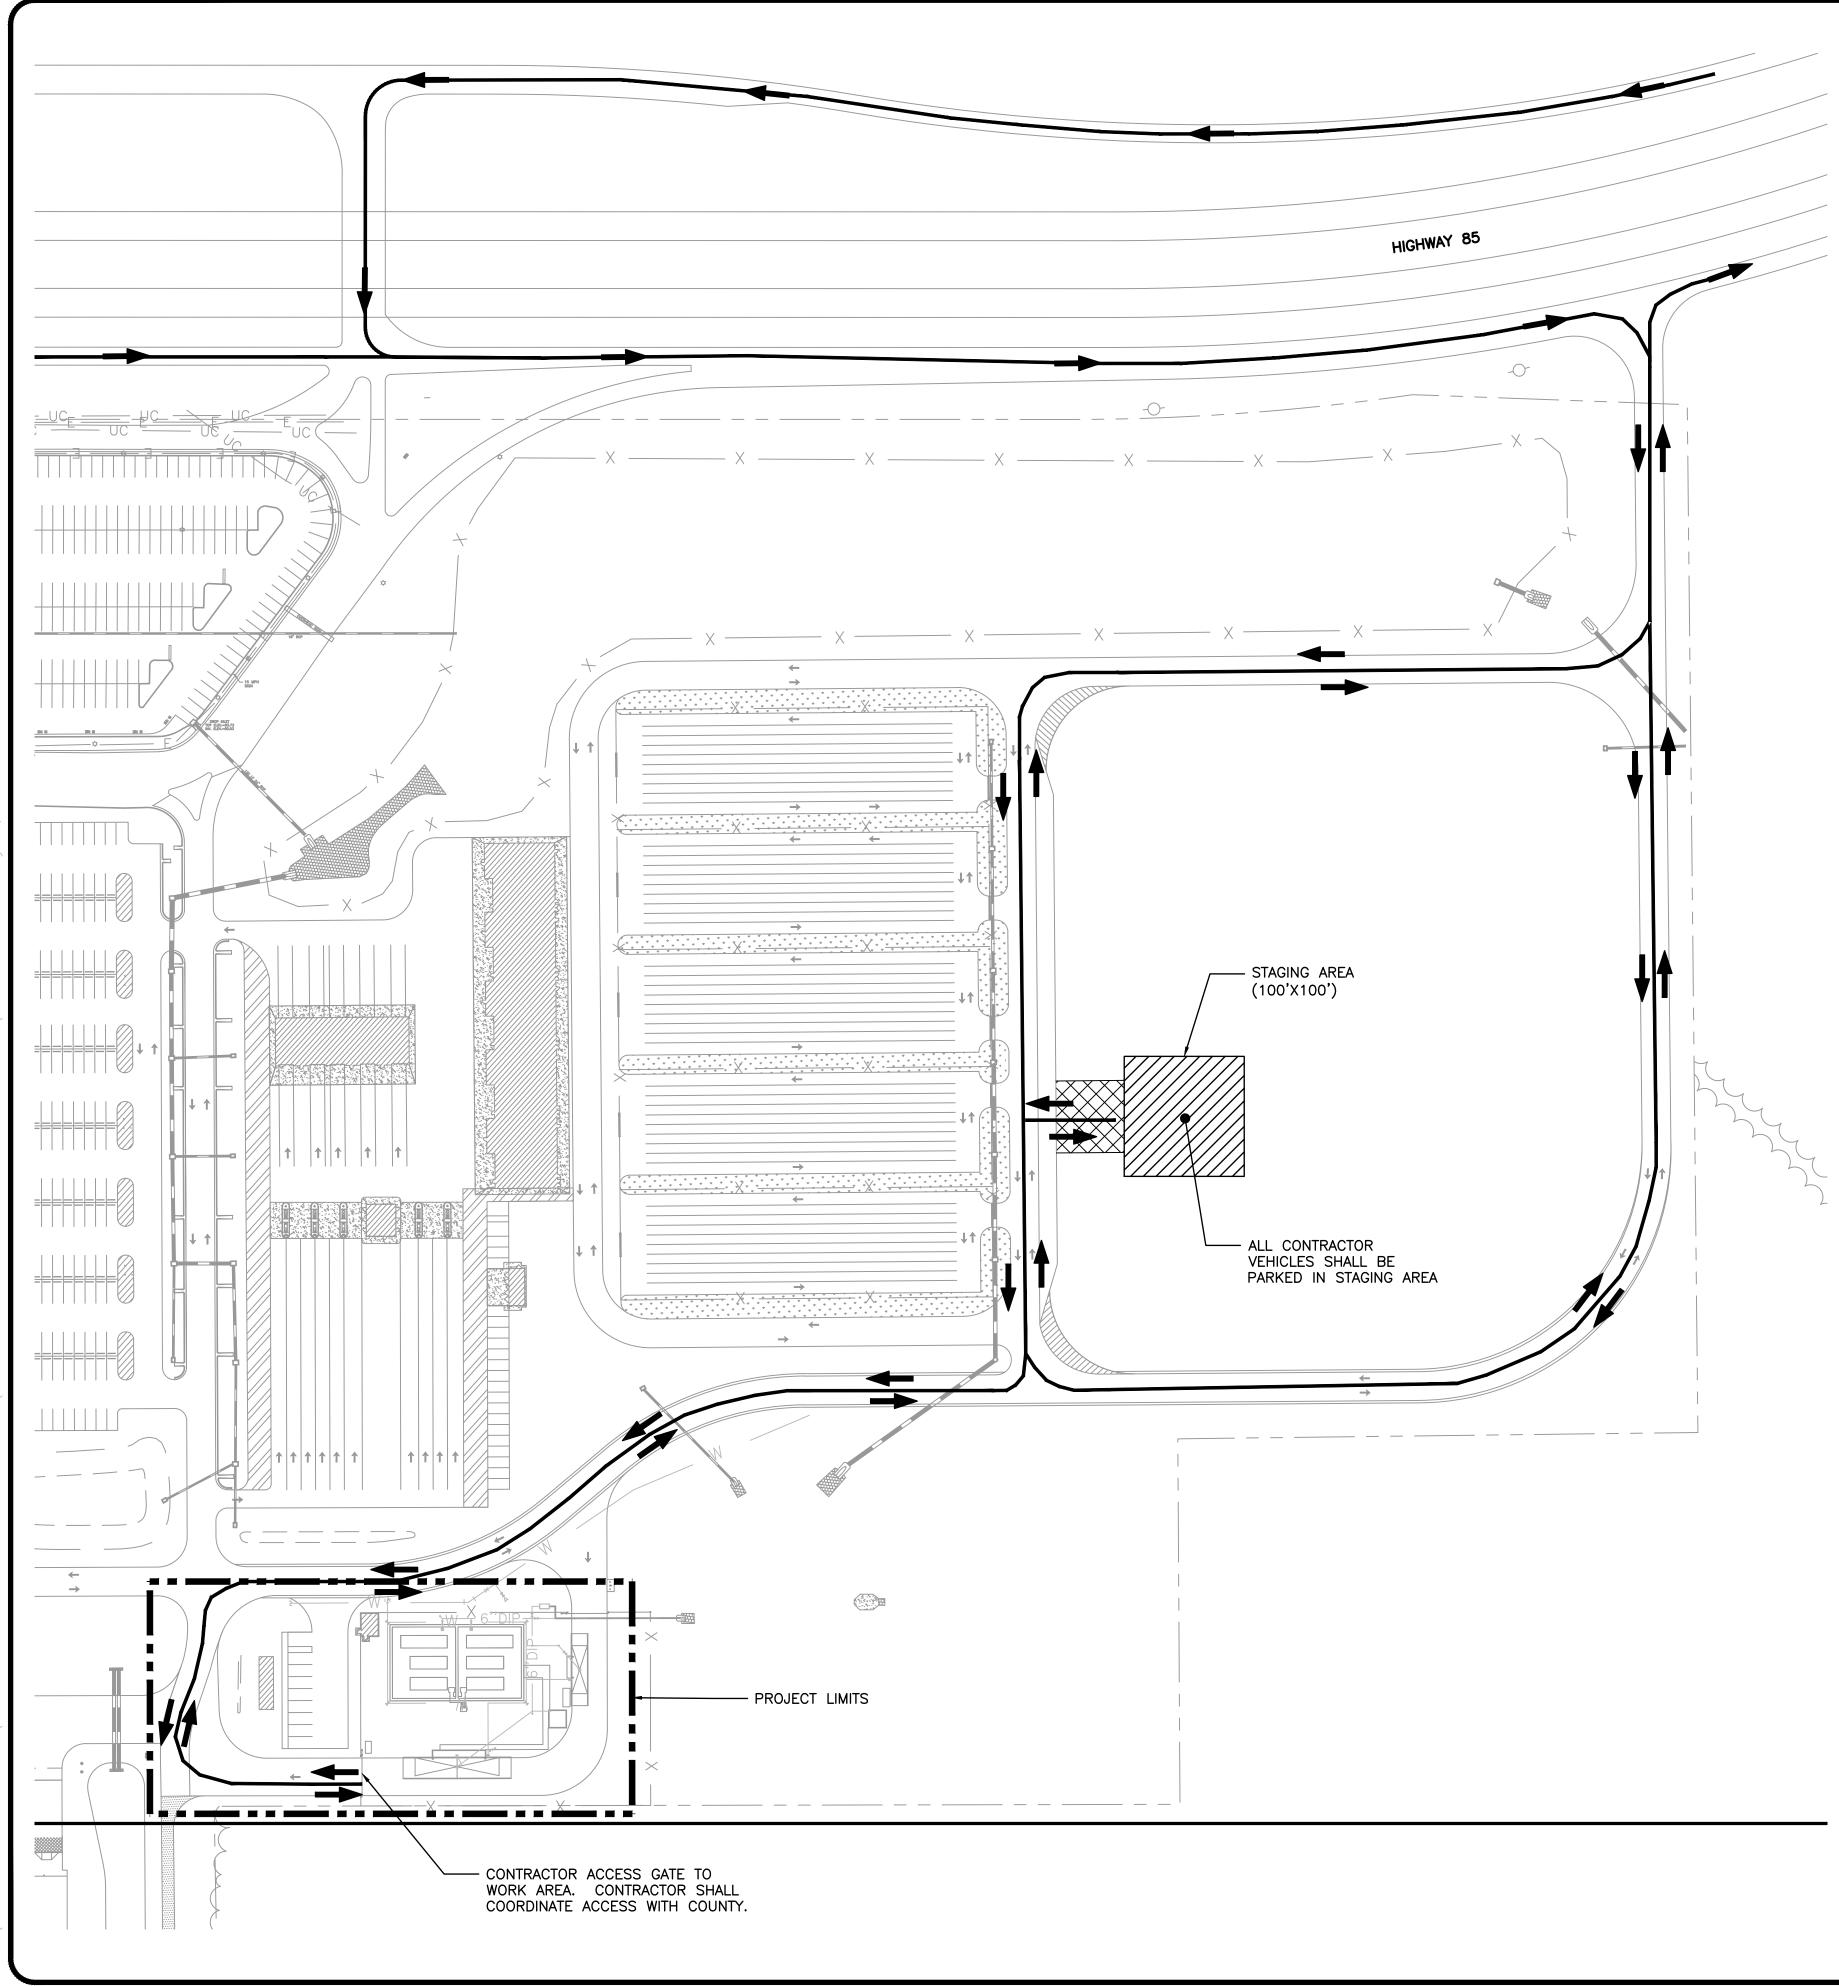
### **RECORD DRAWINGS**

J.R.C.
S.M.M.
J.R.C.
V.C.L.
FEBRUARY 2019

AVCON PROJECT NO.

2017.050.02


SHEET NUMBER



	LEGEND
— <b>—</b>	ACCESS ROUTE
	STAGING AREA
	PROJECT LIMITS
	ANTI-SOIL TRACKING MAT

### NOTES:

- 1. IN THE EVENT TEMPORARY HAUL ROUTES ARE REQUIRED, THE CONTRACTOR SHALL A HAULING ROUTE IS NO LONGER NEEDED, THE AREA (INCLUDING ALL NEW PAVEMENT DAMAGED FROM HAUL ROUTE CROSSINGS) SHALL BE RESTORED TO ITS ORIGINAL OR DRAINAGE, GRADING, AND OTHER MISCELLANEOUS CONSTRUCTION REQUIRED TO CONSTRUCT TEMPORARY HAUL ROUTES OR ACCESS POINTS WILL BE THE CONTRACTOR'S TOTAL RESPONSIBILITY AND SHALL BE APPROVED BY THE AIRPORT PRIOR TO WORK.
- 2. CONTRACTOR SHALL COORDINATE STAGING AREA WITH OWNER'S REPRESENTATIVE ON SITE.
- CONTRACTOR SHALL RESTORE CONTRACTOR STAGING AREA TO ITS ORIGINAL OR BETTER 3. CONDITION AT HIS/HER OWN EXPENSE.
- 4. SILT FENCE SHALL BE INSTALLED COMPLETELY AROUND STAGING AREA.
- 5. CONTRACTOR IS SOLELY RESPONSIBLE FOR SECURING MATERIALS IN STAGING AREA. OKALOOSA COUNTY IS NOT RESPONSIBLE FOR ANY LOST OR DAMAGED MATERIALS OR EQUIPMENT.

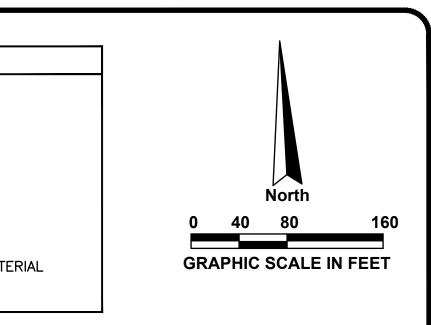

CONSTRUCT HAUL ROUTES CAPABLE OF ADEQUATELY SUPPORTING HAULING UNITS. WHEN PROPOSED CONDITION. NO SEPARATE PAYMENT WILL BE MADE FOR THIS WORK. FENCING,



320 BAYSHORE DRIVE, SUITE A NICEVILLE, FL 32578 PHONE: (850) 678-0050 FAX: (850) 678-0040

FBPR CERTIFICATE OF **AUTHORIZATION NO. 5057** 

# **DESTIN-FORT** WALTON BEACH AIRPORT

# FUEL FARM EXPANSION

# CONTRACTOR ACCESS PLAN

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### **RECORD DRAWINGS**


DESIGNED BY:	J.R.C.
DRAWN BY:	S.M.M.
CHECKED BY:	J.R.C.
APPROVED BY:	V.C.L.
DATE:	FEBRUARY 2019

AVCON PROJECT NO.

SHEET NUMBER

2017.050.02

**C-003** 

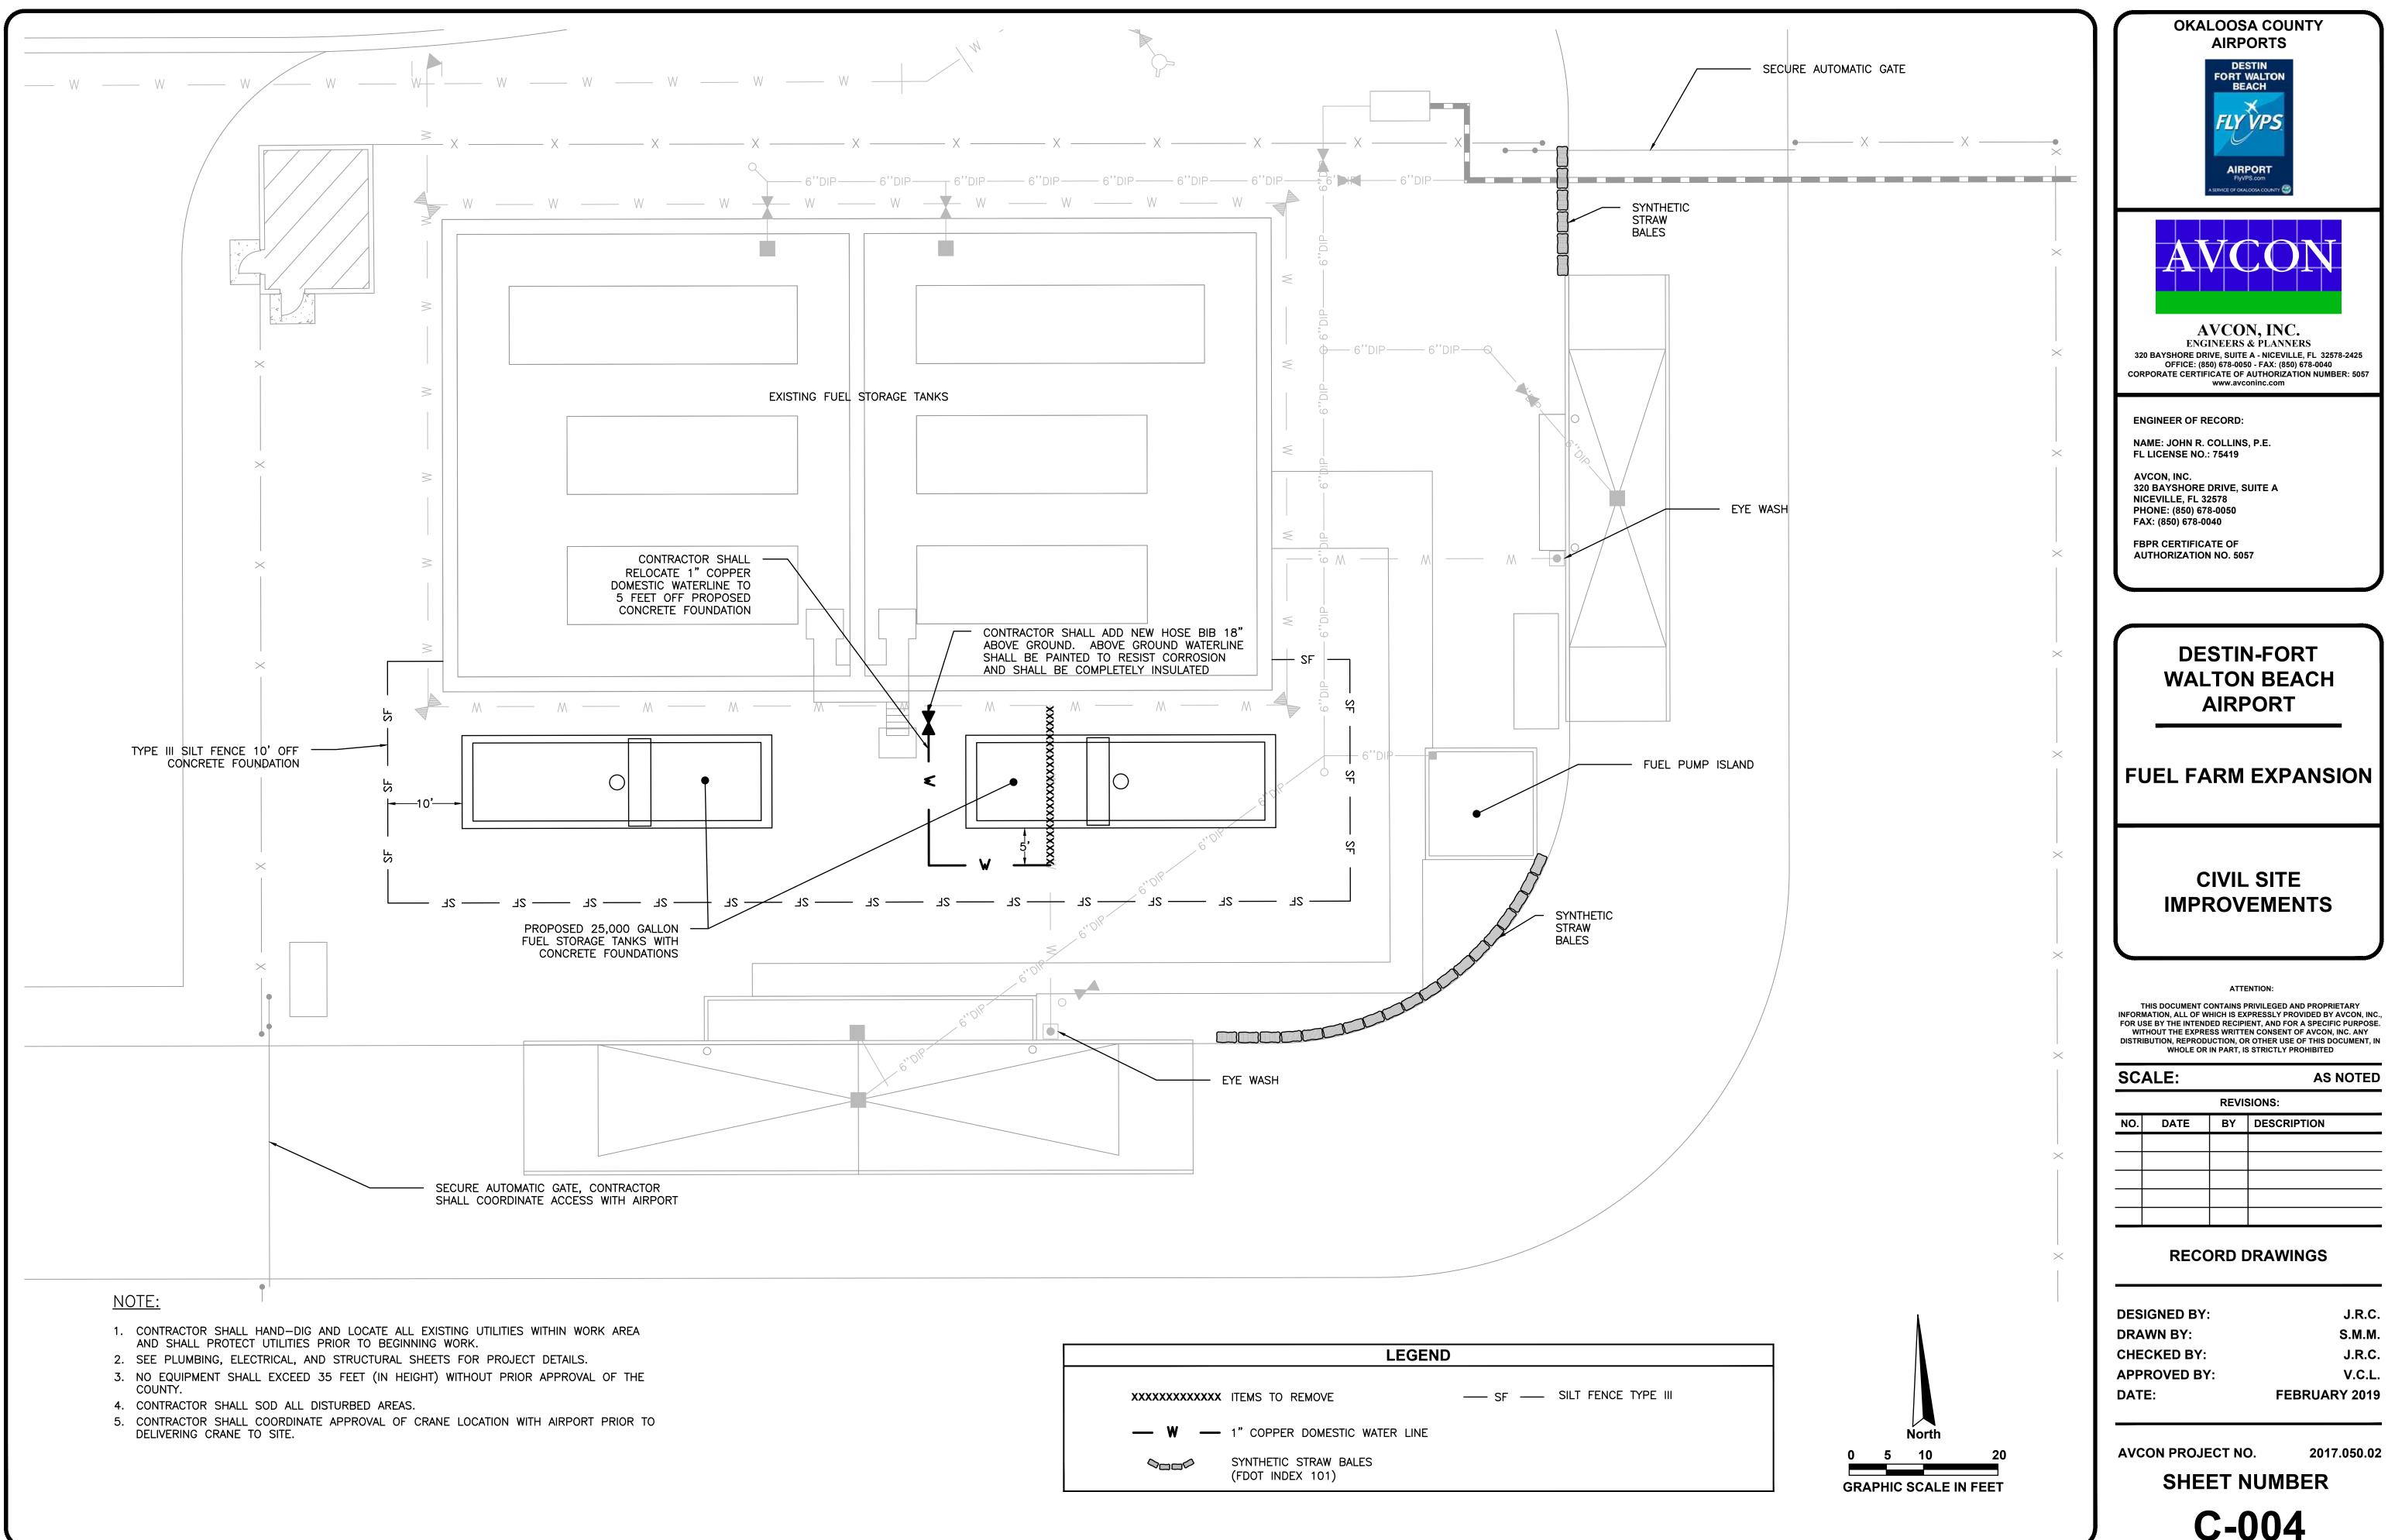

# GENERAL NOTES

- 1. TO THE BEST OF OUR KNOWLEDGE. THE STRUCTURAL PLANS AND SPECIFICATIONS COMPLY WITH THE APPLICABLE REQUIREMENTS OF THE FOLLOWING GOVERNING DESIGN CODES:
  - A. FLORIDA BUILDING CODE 2014 EDITION
  - B. AISC STEEL CONSTRUCTION MANUAL (13TH EDITION)
  - C. BUILDING CODE REQUIREMENTS FOR STRUCTURAL CONCRETE, (ACI 318–11)
  - D. MINIMUM DESIGN LOADS FOR BUILDINGS AND OTHER STRUCTURES (ASCE 7–10)
  - E. STRUCTURAL WELDING CODE AWS D1.1. 2008
- 2. THE STRUCTURAL DOCUMENTS ARE TO BE USED IN CONJUNCTION WITH THE MECHANICAL. ELECTRICAL, PLUMBING AND CIVIL DOCUMENTS, USE THESE NOTES IN CONJUNCTION WITH THE PROJECT SPECIFICATIONS. IF A CONFLICT EXISTS. THE MORE STRINGENT GOVERNS.
- 3. SEE PROJECT SPECIFICATIONS FOR TESTING.
- 4. THE CONTRACTOR SHALL REVIEW ALL CONTRACT DOCUMENTS; INCLUDING DIMENSIONS, AND SITE CONDITIONS AND COORDINATE WITH FIELD DIMENSIONS AND PROJECT SHOP DRAWINGS PRIOR TO CONSTRUCTION. ANY AND ALL DISCREPANCIES SHALL BE SUBMITTED IN WRITING TO ARCHITECT / ENGINEER. DO NOT MODIFY OR CHANGE THE SIZE OR DIMENSIONS OF STRUCTURAL MEMBERS WITHOUT WRITTEN INSTRUCTIONS FROM THE STRUCTURAL ENGINEER OF RECORD.
- 5. IT SHALL BE THE RESPONSIBILITY OF THE SUBCONTRACTOR TO LOCATE ANY AND ALL EXISTING UTILITIES WHETHER SHOWN HEREON OR NOT, AND TO PROTECT EXISTING FACILITIES, STRUCTURES AND UTILITY LINES FROM ALL DAMAGE. EACH CONTRACTOR SHALL PROTECT HIS WORK, ADJACENT PROPERTY AND THE PUBLIC. EACH CONTRACTOR IS SOLELY RESPONSIBLE FOR DAMAGE OR INJURY DUE TO HIS ACT OR NEGLECT.
- 6. WHERE A CONSTRUCTION DETAIL IS NOT SHOWN OR NOTED, THE DETAIL SHALL BE THE SAME AS FOR OTHER SIMILAR WORK. DETAILS LABELED "TYPICAL DETAILS" ON THE DRAWINGS APPLY TO ALL SITUATIONS THAT ARE THE SAME OR SIMILAR TO THOSE SPECIFICALLY DETAILED. ANY QUESTIONS REGARDING APPLICABILITY OF TYPICAL DETAILS SHALL BE RESOLVED BY THE ARCHITECT / ENGINEER.
- 5. DESIGN LOAD CRITERIA:
- B. GRAVITY LOADS:
- D. WIND LOADS:

- 6. DO NOT SCALE THE DRAWINGS, USE DIMENSIONS SHOWN ON PLAN IN CONJUNCTION WITH THE PLUMBING DOCUMENTS. IF A CONFLICT EXISTS, NOTIFY THE ENGINEER OF RECORD IN WRITING FOR RESOLUTION OF ANY AND ALL CONFLICTS.

# SHALLOW FOUNDATIONS

- 1. FOUNDATION DESIGN HAS BEEN PERFORMED BASED ON THE REPORT BY LMJ, FILE #16-243 AND SOIL BEARING CAPACITY SHALL NOT EXCEED 2000 PSF FOR FOOTINGS. THE SOIL SHALL BE COMPACTED TO MINIMUM REQUIREMENTS SET FORTH IN THE REPORT BY LMJ BEFORE PLACEMENT OF CONCRETE.
- 2. IF BEARING SOIL IS DISTURBED DURING FOUNDATION PREPARATION. THE CONTRACTOR SHALL RECOMPACT TO REQUIRED DENSITY, AS DEFINED BY THE GEOTECHNICAL ENGINEER.
- 3. ALL WALLS AND COLUMNS SHALL BE CENTERED ON THE FOOTINGS U.N.O., SEE PLANS
- 4. DO NOT EXCAVATE FOR ANY PURPOSE WITHIN ONE FOOT OF THE ANGLE OF REPOSE OF ANY SOIL BEARING FOOTING OR FOUNDATION UNLESS FOOTING OR FOUNDATION IS FIRST PROPERLY PROTECTED AGAINST SETTLEMENT.
- 5. THE CONTRACTOR IS RESPONSIBLE FOR THE DISPOSAL OF ALL ACCUMULATED WATER FROM EXCAVATIONS AND DEWATERING OPERATIONS IN SUCH A WAY AS NOT TO CAUSE INCONVENIENCE TO THE WORK AND DAMAGE TO THE STRUCTURAL ELEMENTS.

)	$\square$	REINFORCED CONCRETE NOTES	$\square$	
	1.	ALL CAST-IN-PLACE CONCRETE WORK SHALL BE IN ACCORDANCE WITH ACI 318-11 AND ACI 301, EXCEPT AS MODIFIED BY THE PROJECT CONSTRUCTION DOCUMENTS. ALL CONCRETE WORK SHALL BE PERFORMED IN ACCORDANCE WITH SPECIFICATION SECTION 03300.	1.	F II S S
	2.	ALL CONCRETE SHALL MEET THE PROJECT SPECIFICATIONS AND SHALL DEVELOP COMPRESSIVE STRENGTHS AS FOLLOWS (28 DAY STRENGTH):	2.	(
		<ul><li>A. NORMAL WEIGHT CONCRETE (145 PCF)</li><li>B. FOUNDATION, WALLS, SLAB ON GRADE</li></ul>		F
		PROVIDE CURRENT (MAX. 1 YEAR OLD) STATISTICAL DATA FOR EACH CONCRETE MIX SUBMITTED IN ACCORDANCE WITH ACI 318–11.	3.	L
	3.	ALL REINFORCING BARS FOR CONCRETE SHALL HAVE A MINIMUM YIELD STRENGTH OF 60,000 PSI AND MEET THE REQUIREMENTS OF ASTM A-615. FOR PLACEMENT OF	0.	
		REINFORCING CONFORM TO ACI-301, ACI-315, ACI-318, AND CRSI "MANUAL OF STANDARD PRACTICE". ALL REINFORCING SHALL BE ACCURATELY PLACED, RIGIDLY SUPPORTED, AND FIRMLY TIED IN PLACE WITH BAR SUPPORTS AND SPACERS IN ACCORDANCE WITH THE ABOVE REQUIREMENTS. PROVIDE CLASS "B" LAP SPLICE FOR CONTINUOUS BARS. USE THE FOLLOWING COVER:		, E C E F
		<ul> <li>A. CONCRETE COVER REQUIREMENTS FOR REINFORCEMENT, U.N.O.</li> <li>CONCRETE CAST AGAINST EARTH</li></ul>	4.	l L
		<ul> <li>#5 REINFORCEMENT AND SMALLER</li></ul>	5.	V A C
	4.	NO CONDUIT PLACED IN CONCRETE SLAB SHALL HAVE AN OUTSIDE DIAMETER GREATER THAN 1/3 THE THICKNESS OF THE SLAB. NO CONDUIT SHALL BE EMBED IN A SLAB THAT IS LESS THAN 4" THICK. MINIMUM CLEAR DISTANCE SHALL BE IN ACCORDANCE WITH ACI 318.		
	5.	ALL REINFORCING BARS, ANCHOR BOLTS, DOWELS AND OTHER CONCRETE INSERTS SHALL BE SECURED ADEQUATELY IN POSITION PRIOR TO PLACEMENT OF CONCRETE. CONTRACTOR SHALL USE TEMPLATES TO INSURE ACCURATE PLACEMENT OF ANCHOR BOLTS, DOWELS, ETC.	6.	A A C
	6.	ALL CONCRETE SHALL BE CONSOLIDATED BY USE OF A MECHANICAL VIBRATOR OR OTHER MEANS APPROVED BY THE ENGINEER.	7.	A C A
	7.	CONCRETE SHALL COMPLY WITH ALL THE REQUIREMENTS OF ASTM STANDARD C94 FOR MEASURING, MIXING, TRANSPORTING, ETC. CONCRETE TICKETS SHALL BE TIME STAMPED WHEN CONCRETE IS BATCHED. CONCRETE SHALL BE PLACED IN ITS FINAL POSITION WITHIN 90 MINUTES AFTER ADDITION OF BATCH WATER. CONCRETE SHALL BE DISCARDED IF THE FOREGOING ELAPSED TIME IS EXCEEDED.	8.	C A A
		STRUCTURAL SUBMITTALS		C
	1.	IN ADDITION TO SUBMITTALS REQUIRED BY THE PROJECT SPECIFICATIONS AND CONSTRUCTION DOCUMENTS, THE FOLLOWING "STRUCTURAL SUBMITTALS" ARE REQUIRED FOR REVIEW BY THE STRUCTURAL ENGINEER OF RECORD.		
		<ul><li>A. REINFORCED CONCRETE LAYOUT AND DETAILS</li><li>B. NEW STRUCTURAL STEEL FRAMING, INCLUDING LADDER, CATWALK, ETC.</li></ul>	9.	F

2. ALL STRUCTURAL SUBMITTALS SHALL BE PREPARED AND SUBMITTED TO THE E.O.R.

REFERENCE STANDARDS: STRUCTURAL STEEL SHALL BE DETAILED, FABRICATED AND ERECTED IN ACCORDANCE WITH THE AISC STEEL CONSTRUCTION MANUAL AND THE AISC CODE OF STANDARD PRACTICE (REFERENCED EDITION) WITH EXCEPTION NOTED IN THE PROJECT SPECIFICATIONS.

- **OSHA REQUIREMENTS:**
- REGULATIONS.
- STRUCTURE DURING THE INSTALLATION OF STRUCTURAL STEEL MEMBERS.
- DESIGNATIONS U.N.O.

- WELDING WHEN OBTAINABLE.
- SURFACES. MINIMUM FILLET WELD SIZE IS 3/16".
- QUALIFICATION TESTS. CERTIFICATION MUST BE CURRENT.
- QUALIFIED PRIOR TO USE ACCORDING TO AWS PROCEDURES.
- A325 BOLTS:
  - STRUCTURAL STEEL JOINTS. DO NOT USE TYPE 2 BOLTS.
  - WASHERS UNDER PART BEING TURNED.
- A325 BOLTS. OR LUBRICATED WITH JOHNSON'S STICK WAX 140.
- BE SUBMITTED FOR APPROVAL PRIOR TO BEGINNING WORK.
- USE A FLAME TO CUT OR ENLARGE HOLES IN STRUCTURAL STEEL MEMBERS.
- NOT LIMITED TO EDGE ANGLES, CLOSURE PLATES, AND DECK SUPPORT FRAMING.
- 12. ALL EXTERIOR EXPOSED STEEL SHALL BE HOT DIP GALVANIZED.
- STEEL THAT WILL BE REQUIRED.

# STRUCTURAL STEEL

A. THE CONTRACTOR SHALL PROVIDE ADDITIONAL ANCHORS, BOLTS, STABILIZERS, STIFFENERS, BRIDGING, BRACING, ETC. AS NECESSARY TO COMPLY WITH CURRENT OSHA B. THE CONTRACTOR SHALL PROVIDE ALL NECESSARY SHORING TO INSURE A STABLE

MATERIAL REQUIREMENTS OF STRUCTURAL STEEL SHALL CONFORM TO THE FOLLOWING

B. ANGLES, CHANNELS, AND PLATES . . . ASTM A36 OR ASTM A572, GRADE 50 C. HSS SECTIONS . . . . . . . . . . . . . . . ASTM A500, GRADE "B" (Fy = 46KSI) . ANCHOR BOLTS . . . . . . . . . . . . . . ASTM F1554. GRADE 36 (WELDABLE) 

USE STRUCTURAL STEEL THAT IS FULLY WELDABLE INCLUDING WHEN WELDING BETWEEN DIFFERENT GRADES OF STEEL. SHOP WELDING SHALL BE UTILIZED IN LIEU OF FIELD

ALL SHOP AND FIELD WELDING SHALL CONFORM TO THE STRUCTURAL WELDING CODE AWS D1.1, LATEST EDITION, PUBLISHED BY THE AMERICAN WELDING SOCIETY (AWS). USE ELECTRODES CONFORMING TO AWS D1.1, E70 SERIES, U.N.O. SHOW ALL SHOP WELDS ON THE FABRICATION DRAWINGS AND ALL FIELD WELDS ON THE ERECTION DRAWINGS. WELD SIZES AND LENGTHS ARE SHOWN ON THE DRAWINGS. WELD SIZES ARE THE NET EFFECTIVE SIZE REQUIRED. INCREASE THE WIDTH OF THE WELD IF A GAP EXISTS AT FAYING

ALL SHOP AND FIELD WELDERS, WELDING OPERATORS, AND TACKERS SHALL BE CERTIFIED ACCORDING TO AWS PROCEDURES AND HAVE EVIDENCE OF PASSING THE AWS STANDARD

ALL JOINT WELDING PROCEDURES TO BE USED SHALL BE PREPARED BY THE FABRICATOR OR CONTRACTOR AS WRITTEN PROCEDURE SPECIFICATIONS AND SUBMITTED TO THE ARCHITECT/ENGINEER FOR THEIR RECORD. ALL JOINT WELDING PROCEDURES SHALL BE

A. A325 BOLTS SHALL CONFORM TO ASTM A 325 TYPE 1, HIGH STRENGTH BOLTS FOR B. PROVIDE HARDENED WASHERS CONFORMING TO ASTM F 436. PLACE HARDENED

C. LOAD INDICATOR WASHERS OR TENSION CONTROLLED BOLTS SHALL BE USED ON ALL


D. ALL BOLTS SHALL BE NEW AND DOMESTICALLY MANUFACTURED. DO NOT REUSE BOLTS. USE ONLY NON-GALVANIZED NUTS AND BOLTS THAT ARE CLEAN, RUST-FREE, AND WELL LUBRICATED. BOLTS AND NUTS SHALL BE WAX DIPPED BY THE BOLT SUPPLIER

FIELD MODIFICATION OF STRUCTURAL STEEL SHALL NOT BE CUT IN FIELD OR MODIFIED WITHOUT PRIOR APPROVAL OF THE ENGINEER. SPLICING STEEL MEMBERS IS NOT PERMITTED EXCEPT WHERE EXPLICITLY SHOWN ON THE STRUCTURAL DRAWINGS OR WHERE APPROVED BY THE ENGINEER OF RECORD. SPLICES SHALL NOT OCCUR AT LOCATIONS OF MAXIMUM STRESS AND SHALL DEVELOP THE FULL CAPACITY OF THE MEMBER. SPLICE DETAILS SHALL

10. WHEN HOLES ARE REQUIRED IN METAL SURFACE. THEY SHALL BE CUT. DRILLED. OR PUNCHED HOLES PERPENDICULAR TO METAL SURFACE. IN NO INSTANCE IS IT ADEQUATE TO

11. THE STEEL SUPPLIER SHALL PROVIDE ALL MISCELLANEOUS STRUCTURAL STEEL ITEMS NECESSARY TO FULFILL THE INTENT OF THE STRUCTURAL DRAWINGS WHETHER OR NOT THE ITEMS ARE SHOWN ON THE STRUCTURAL DRAWINGS. SUCH ITEMS MAY INCLUDE BUT ARE

13. SEE MECHANICAL, ELECTRICAL, AND PLUMBING DRAWINGS FOR ADDITIONAL MISCELLANEOUS

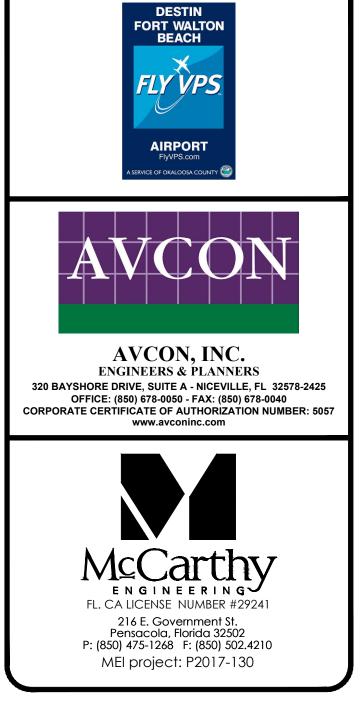

**OKALOOSA COUNTY** 

**AIRPORTS** 

# **DESTIN-FORT** WALTON BEACH **AIRPORT**

# FUEL FARM EXPANSION

# **GENERAL NOTES**

### ATTENTION

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SCALE:			AS NOTED
REVISIONS:			
NO.	DATE	BY	DESCRIPTION

### **RECORD DRAWINGS**

DESIGNED BY:	DJM
DRAWN BY:	WEH
CHECKED BY:	DJM
APPROVED BY:	DJM
DATE:	FEBRUARY 2019

AVCON PROJECT NO.

2017.050.02

SHEET NUMBER

# CHEMICAL ADHESIVE ANCHORAGE

	-	
	1.	ADHESIVE ANCHORS SHALL BE AS SPECIFIED ON THE CONSTRUCTION DRAWINGS OR APPROVED EQUIVALENT. ACCEPTABLE SYSTEMS SHALL INCLUDE: SIMPSON, HILTI (EPOXY OR POLYESTER RESIN ADHESIVE) ANCHORS OR APPROVED EQUIVALENT WITH DIAMETER AND EMBEDMENT LENGTH AS NOTED ON THE DRAWINGS OR IN ACCORDANCE WITH THE MANUFACTURERS SPECIFICATIONS. INSTALL ALL ANCHORAGE PER THE MANUFACTURERS RECOMMENDATIONS.
	2. 3.	DIAMETER OF HOLE SHALL BE AS RECOMMENDED BY MANUFACTURER FOR THE PARTICULAR PRODUCT SPECIFIED IN THE DRAWINGS.
	4.	UNLESS NOTED, ANCHOR SPACING AND ANCHOR EDGE DISTANCE SHALL BE ACCORDING TO THE MANUFACTURER'S MOST CURRENT PUBLICATION IN ORDER TO DEVELOP MAXIMUM WORKING LOADS.
	5.	DO NOT EXCEED MANUFACTURER'S MAX. RECOMMENDED TIGHTENING TORQUE.
	6.	ALL ANCHORS SHALL BE INSTALLED AS PER MANUFACTURER'S RECOMMENDATIONS AND UNDER MANUFACTURER'S SUPERVISION IN ORDER TO DEVELOP THE MOST CURRENT PUBLISHED WORKING LOADS.
	7.	INSTALLATION OF ALL ANCHORS SHALL BE PERFORMED BY PERSONNEL CERTIFIED BY AN APPLICABLE CERTIFICATION PROGRAM. CERTIFICATION SHALL INCLUDE WRITTEN AND PERFORMANCE TESTS IN ACCORDANCE WITH ACI/CRSI ADHESIVE ANCHOR INSTALLER CERTIFICATION PROGRAM OR EQUIVALENT.
	8.	ALL ANCHORS INSTALLED SHALL BE CONTINUOUSLY INSPECTED DURING INSTALLATION BY AN INSPECTOR SPECIALLY APPROVED FOR THAT PURPOSE BY THE BUILDING OFFICIAL. THE SPECIAL INSPECTOR SHALL FURNISH A REPORT TO THE LICENSED DESIGN PROFESSIONAL AND BUILDING OFFICIAL THAT THE WORK COVERED BY THE REPORT HAS BEEN PERFORMED AND THE MATERIALS USED AND THE INSTALLATION PROCEDURES USED CONFORM WITH THE APPROVED CONTRACT DOCUMENTS AND THE MANUFACTURER'S PRINTED INSTALLATION INSTRUCTIONS (MPII)
	9.	TESTING OF EPOXIED ANCHORAGE SHALL BE REQUIRED. THE CONTRACTOR SHALL TEST A MINIMUM OF 10% OF EACH DAYS PRODUCTION AND NOT LESS THAN TWO ANCHORS. THE TEST SHALL BE ACCOMPLISHED BY A APPLYING A TENSILE LOAD OF 1000 POUNDS TO THE EMBED ANCHOR. IF ANY TEST FAILS THE LOAD TEST, ALL APPLICATIONS FOR THAT DAY SHALL BE TESTED. THE TESTING RESULTS SHALL BE REVIEWED BY THE STRUCTURAL ENGINEER.
(		EPOXY ANCHORAGE INSTALLATION NOTES
	HOL	E PREPARATION
	1.	DRILL – DRILL HOLE TO SPECIFIED DIAMETER AND DEPTH.
	2.	BLOW – REMOVE DUST FROM HOLE WITH OIL-FREE COMPRESSED AIR FOR A MINIMUM OF 4 SECONDS. COMPRESSED AIR NOZZLE MUST REACH THE BOTTOM OF THE HOLE.
	3.	BRUSH – CLEAN WITH A NYLON BRUSH FOR A MINIMUM OF 4 CYCLES. BRUSH SHOULD PROVIDE RESISTANCE TO INSERTION. IF NO RESISTANCE IS FELT, THE BRUSH IS WORN AND MUST BE REPLACED.
	4.	BLOW – REMOVE DUST FROM HOLE WITH OIL—FREE COMPRESSED AIR FOR A MINIMUM OF 4 SECONDS. COMPRESSED AIR NOZZLE MUST REACH THE BOTTOM OF THE HOLE.
	<u>CAR</u>	TRIDGE PREPARATION
	5.	CARTRIDGE PREPARATION SHALL INCLUDE CHECKING EXPIRATION DATE ON PRODUCT LABEL. DO NOT USE EXPIRED PRODUCT. PRODUCT IS USABLE UNTIL END OF PRINTED EXPIRATION MONTH.
	6.	ATTACH – ATTACH PROPER NOZZLE TO CARTRIDGE. DO NOT MODIFY NOZZLE.
	7.	INSERT – INSERT CARTRIDGE INTO DISPENSING TOOL.

- 7. INSERT INSERT CARTRIDGE INTO DISPENSING TOOL.
- 8. DISPENSE DISPENSE ADHESIVE TO THE SIDE UNTIL PROPERLY MIXED (UNIFORM COLOR).

### FILLING THE HOLE


- 9. INSTALL ADHESIVE RETAINING CAP. REFER TO ADHESIVE RETAINING CAPS FOR PROPER ARC SIZE.
- 10. FILL FILL HOLE 1/2 2/3 FULL, STARTING FROM BOTTOM OF HOLE TO PREVENT AIR POCKETS. WITHDRAW NOZZLE AS HOLE FILLS UP.
- 11. INSERT CLEAN, OIL-FREE ANCHOR, TURNING SLOWLY UNTIL THE ANCHOR CONTACTS THE BOTTOM OF THE HOLE.
- 12. DO NOT DISTURB THREADED ROD ANCHOR UNTIL FULLY CURED. (SEE CURE SCHEDULE FOR SPECIFIC ADHESIVE IN CONTRACT DOCUMENTS AND COORDINATE WITH THE MANUFACTURERS WRITTEN INSTRUCTIONS.)





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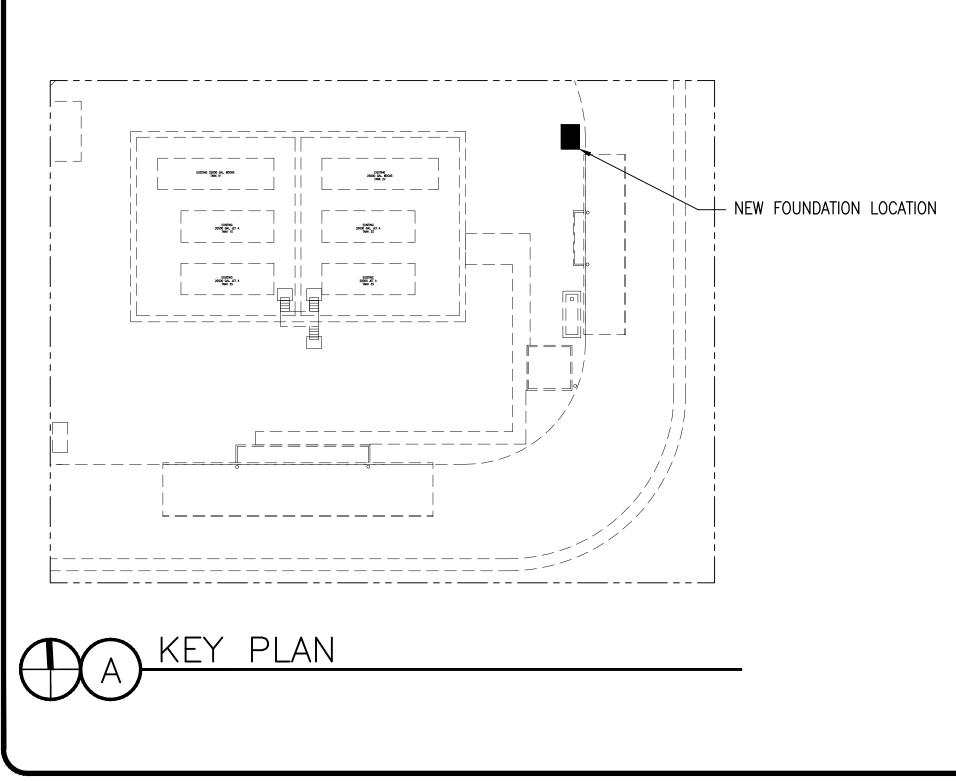
SHEET NUMBER







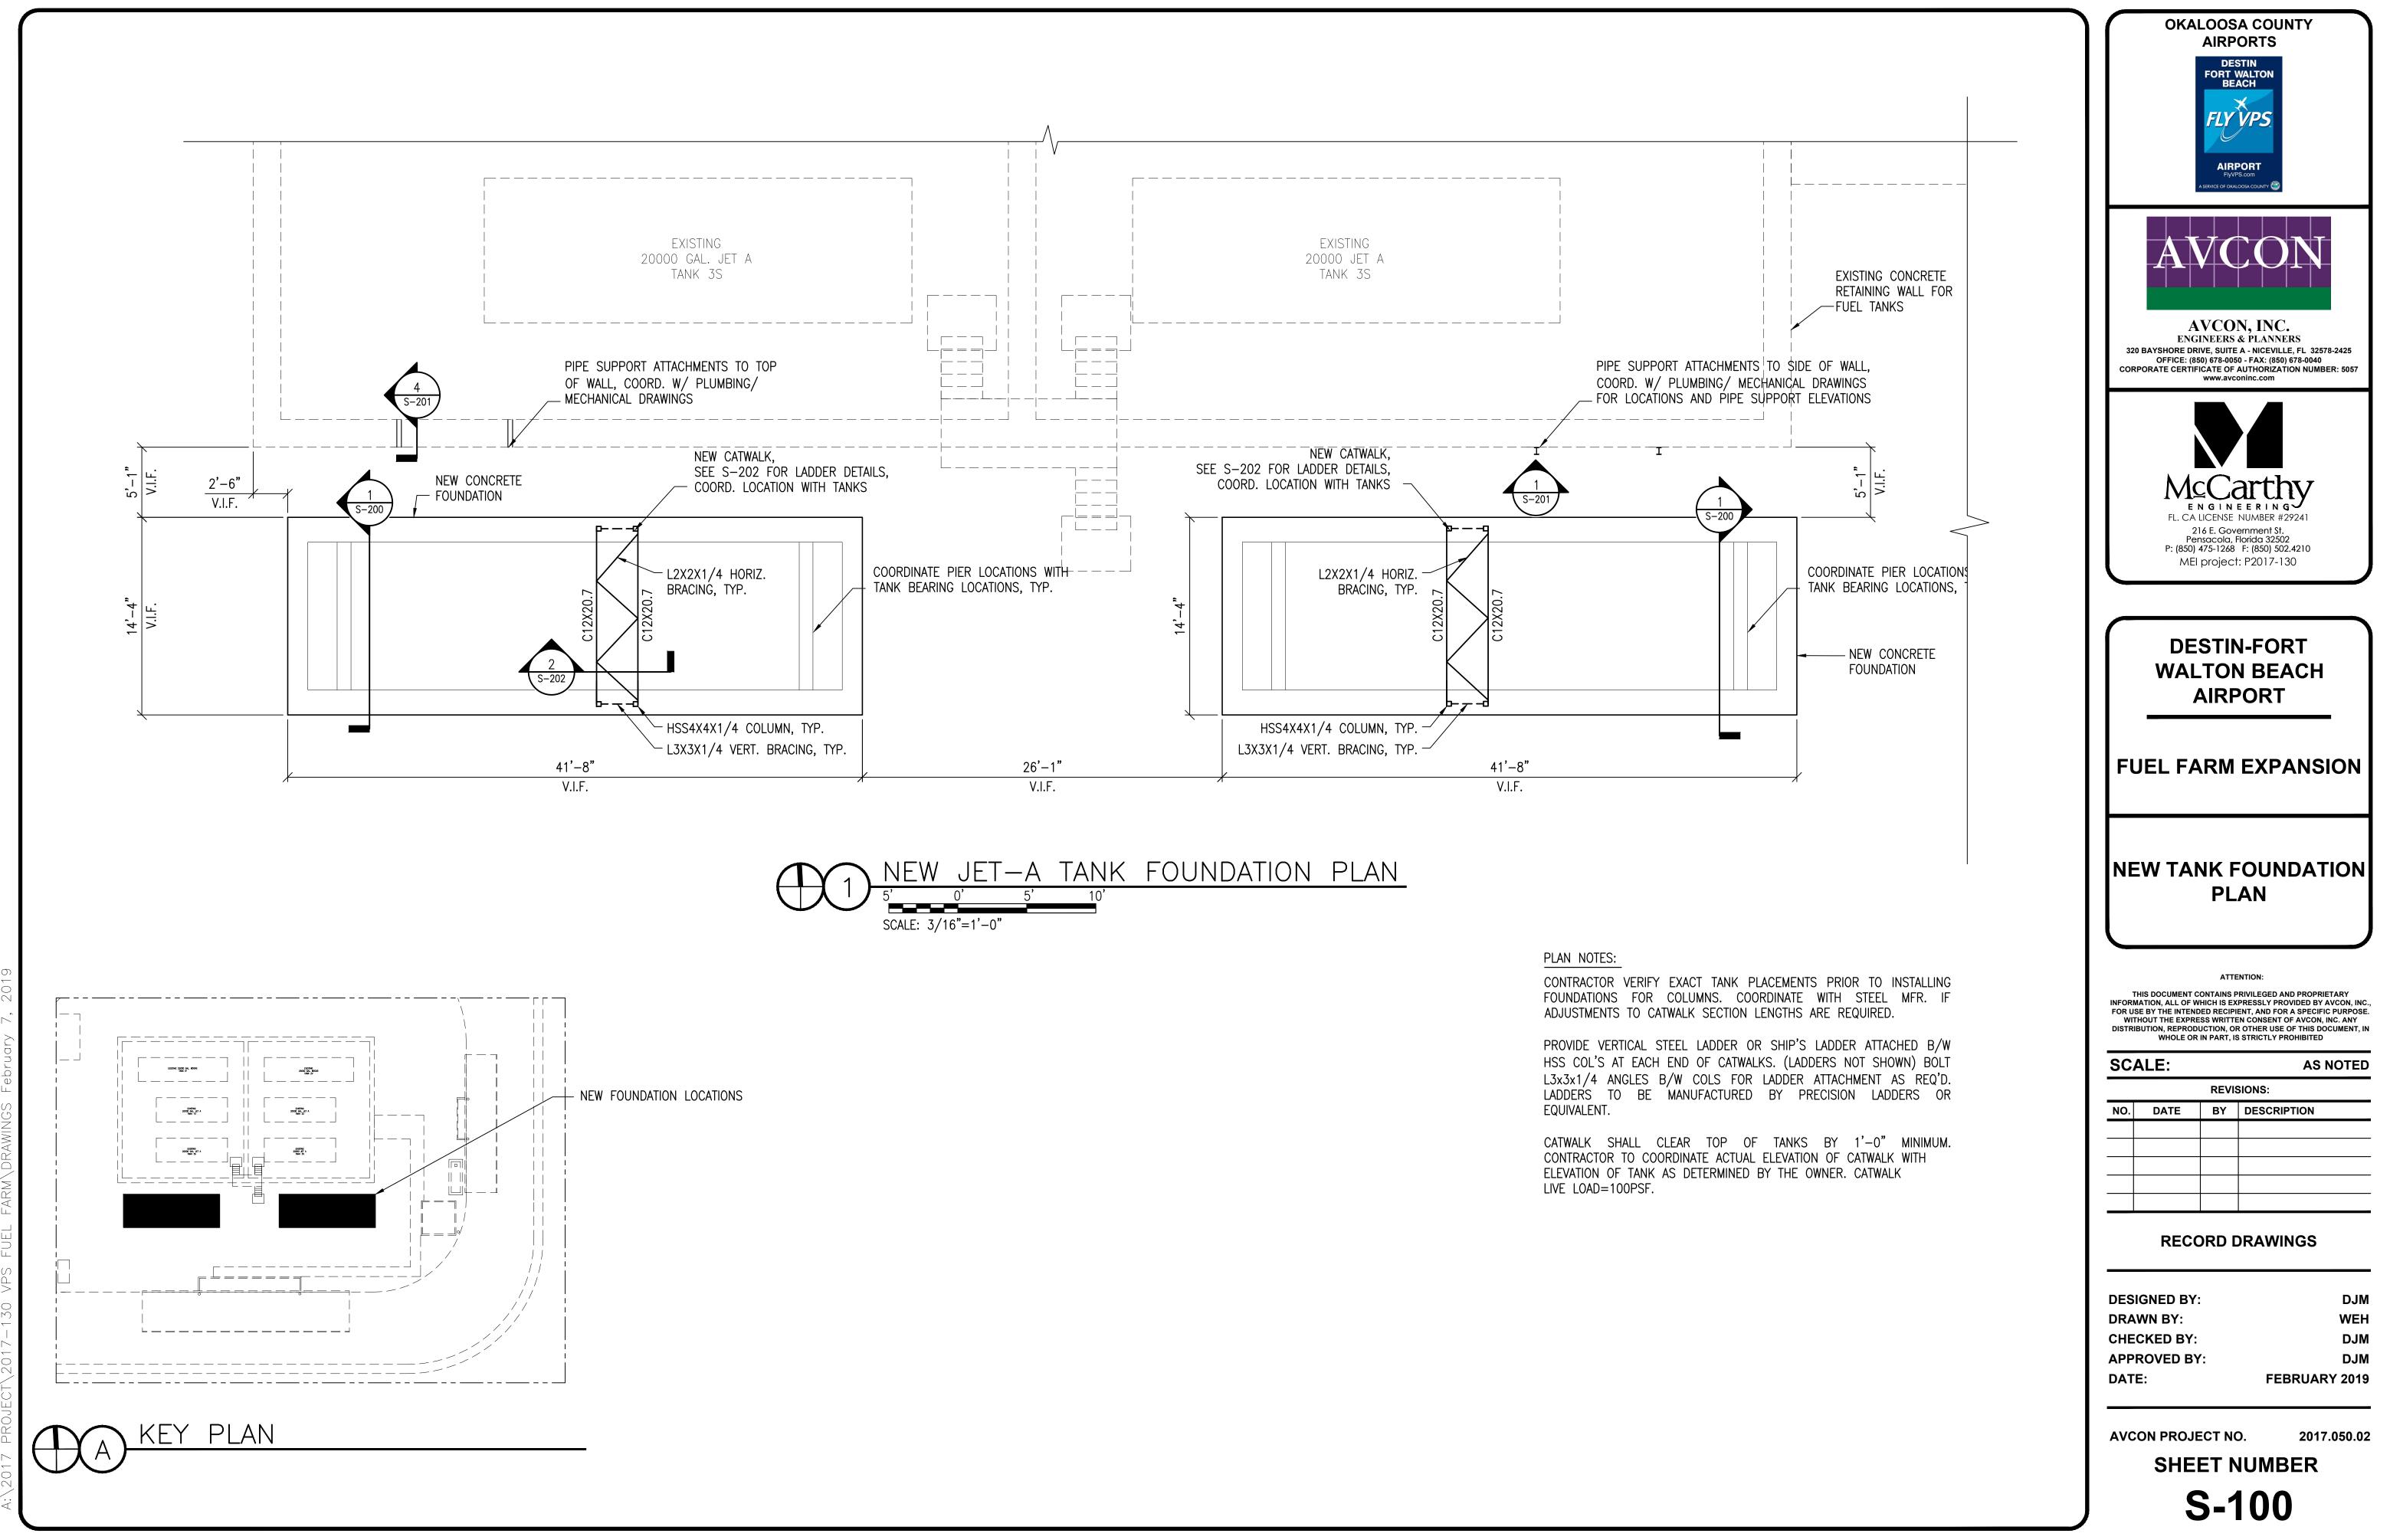


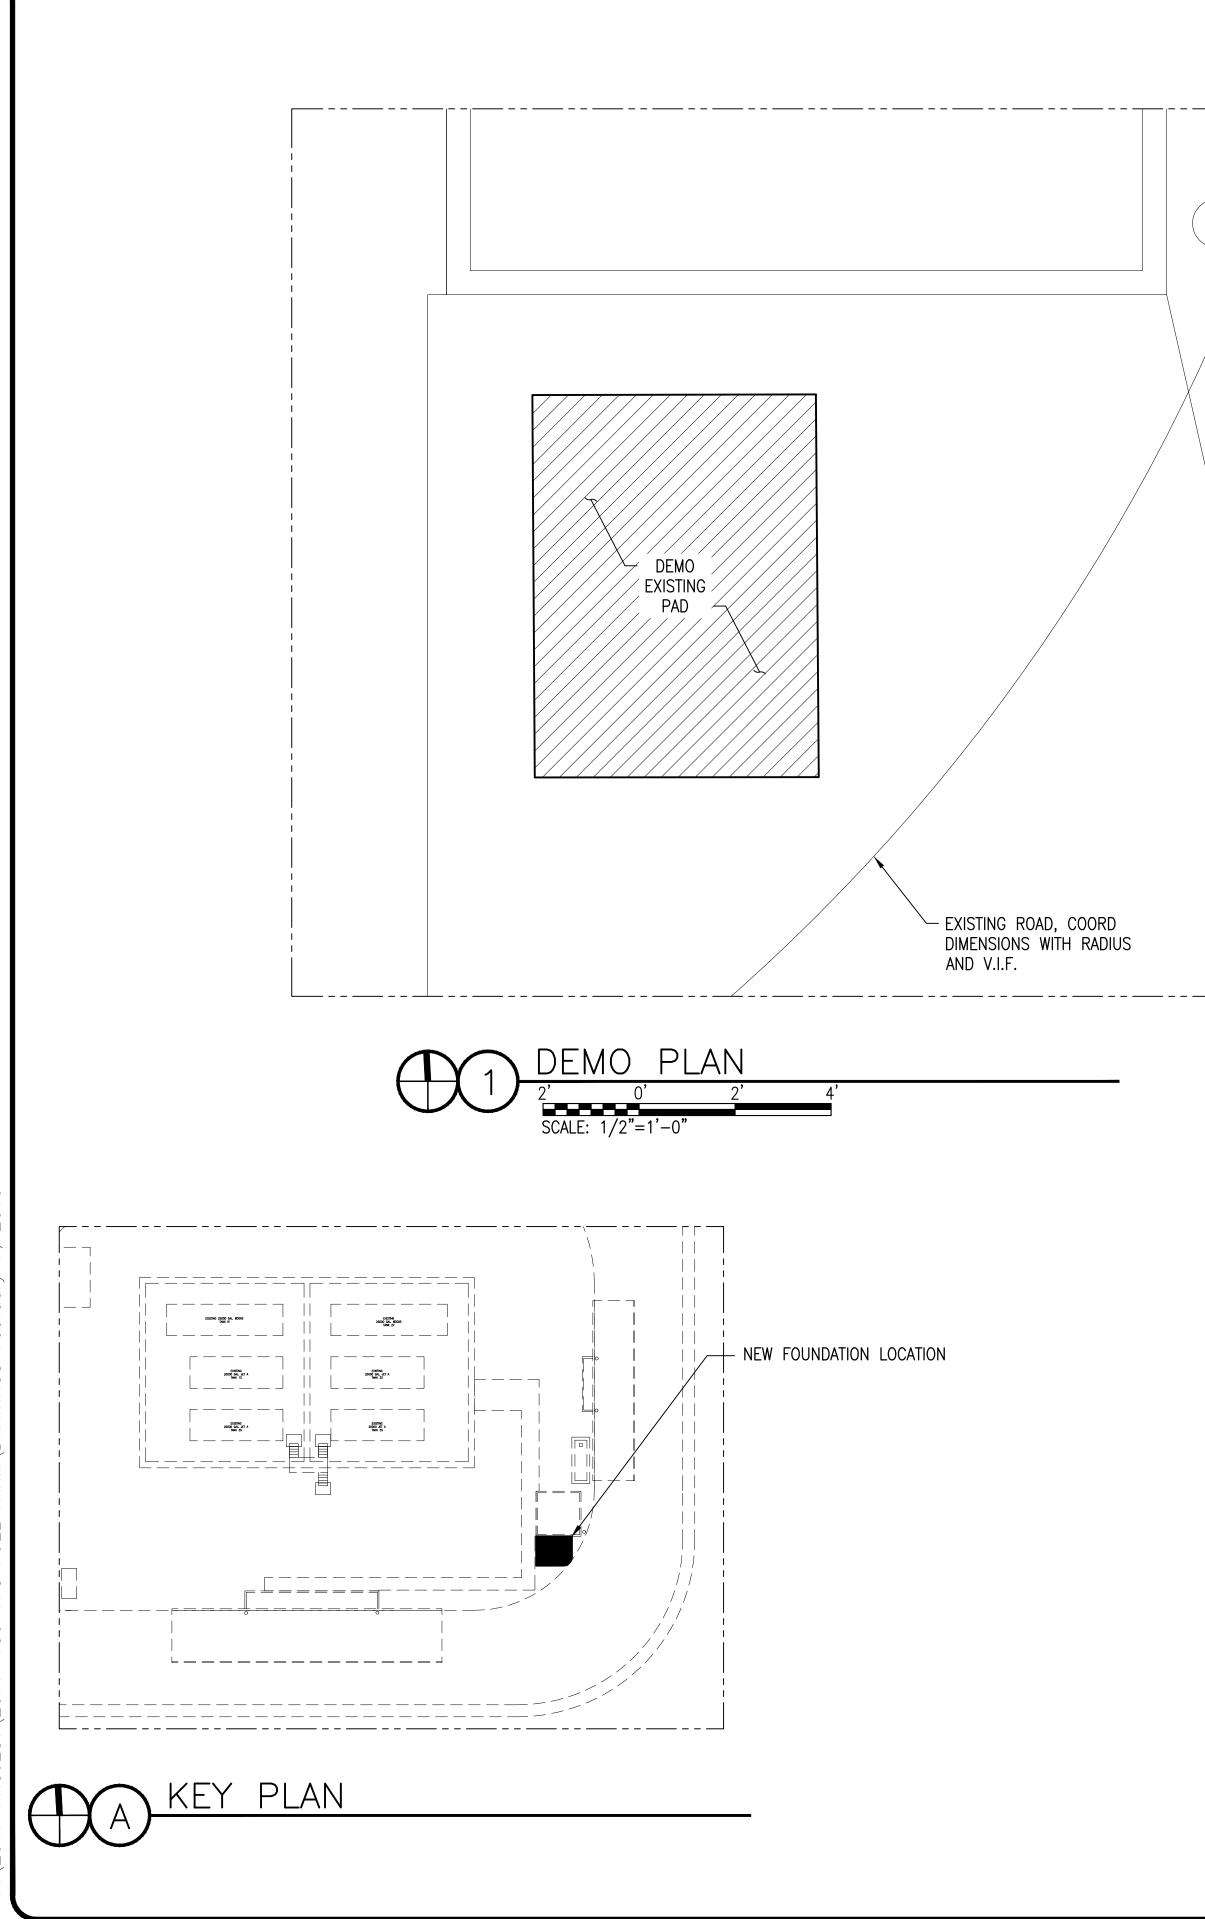


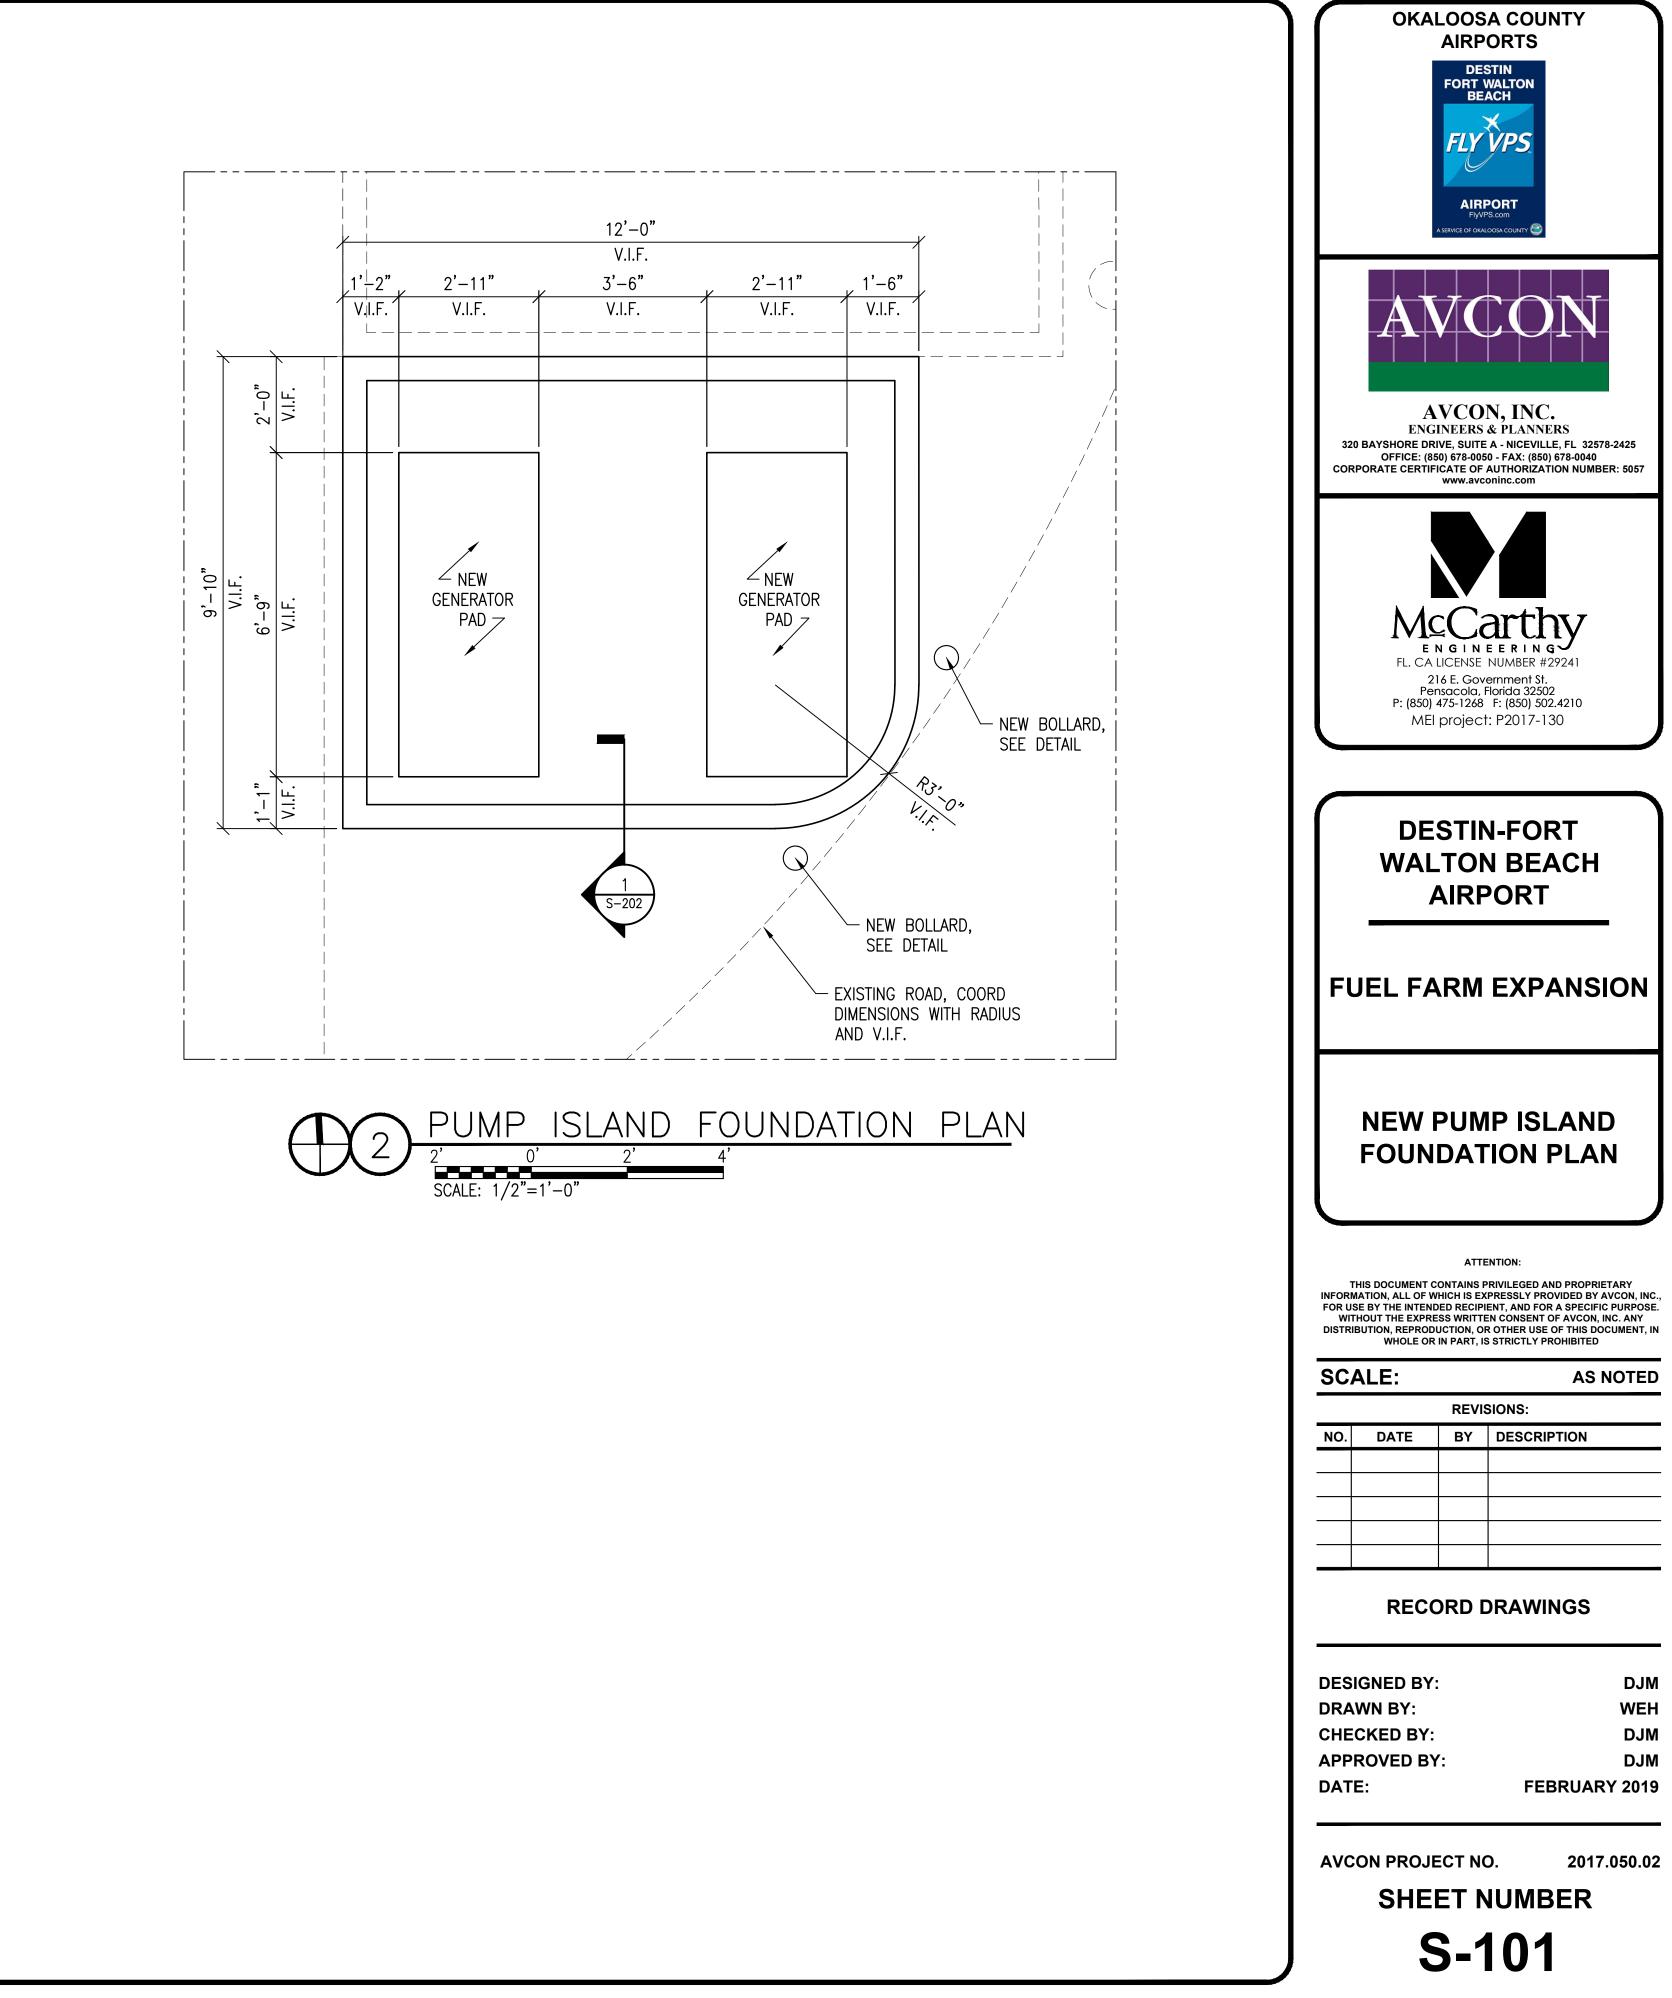

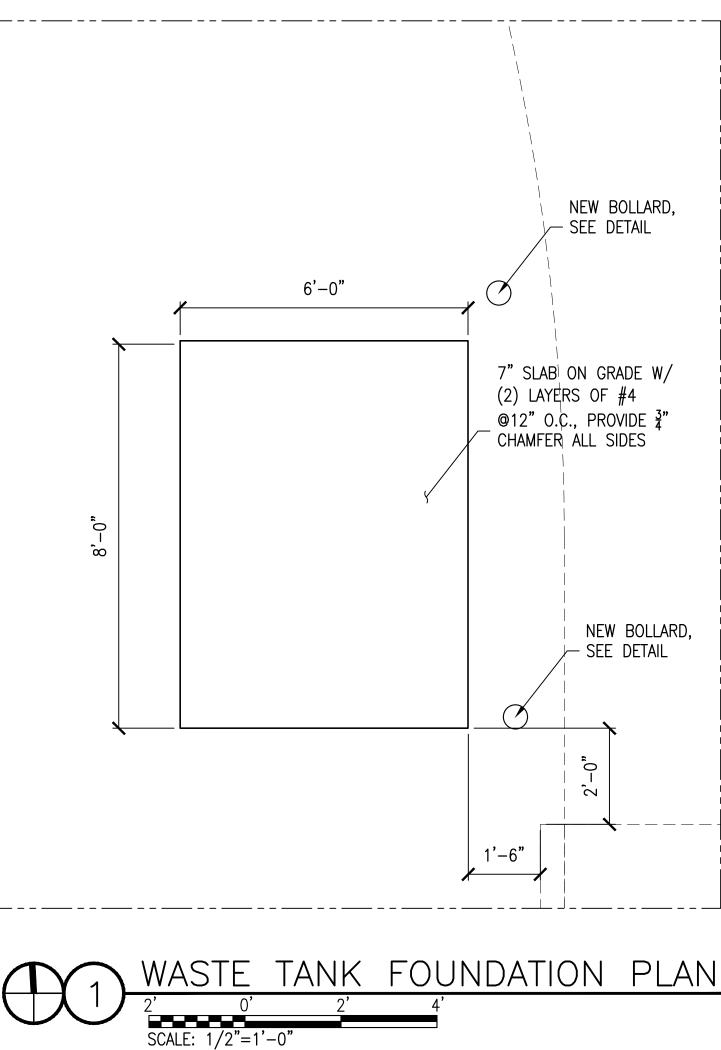

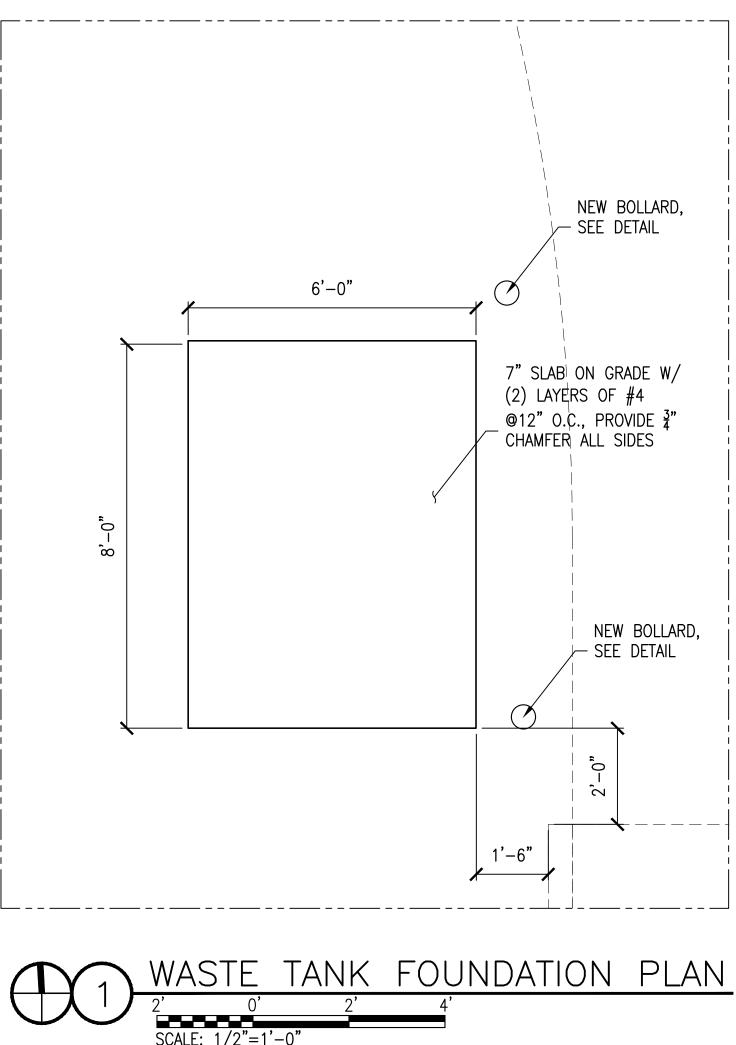

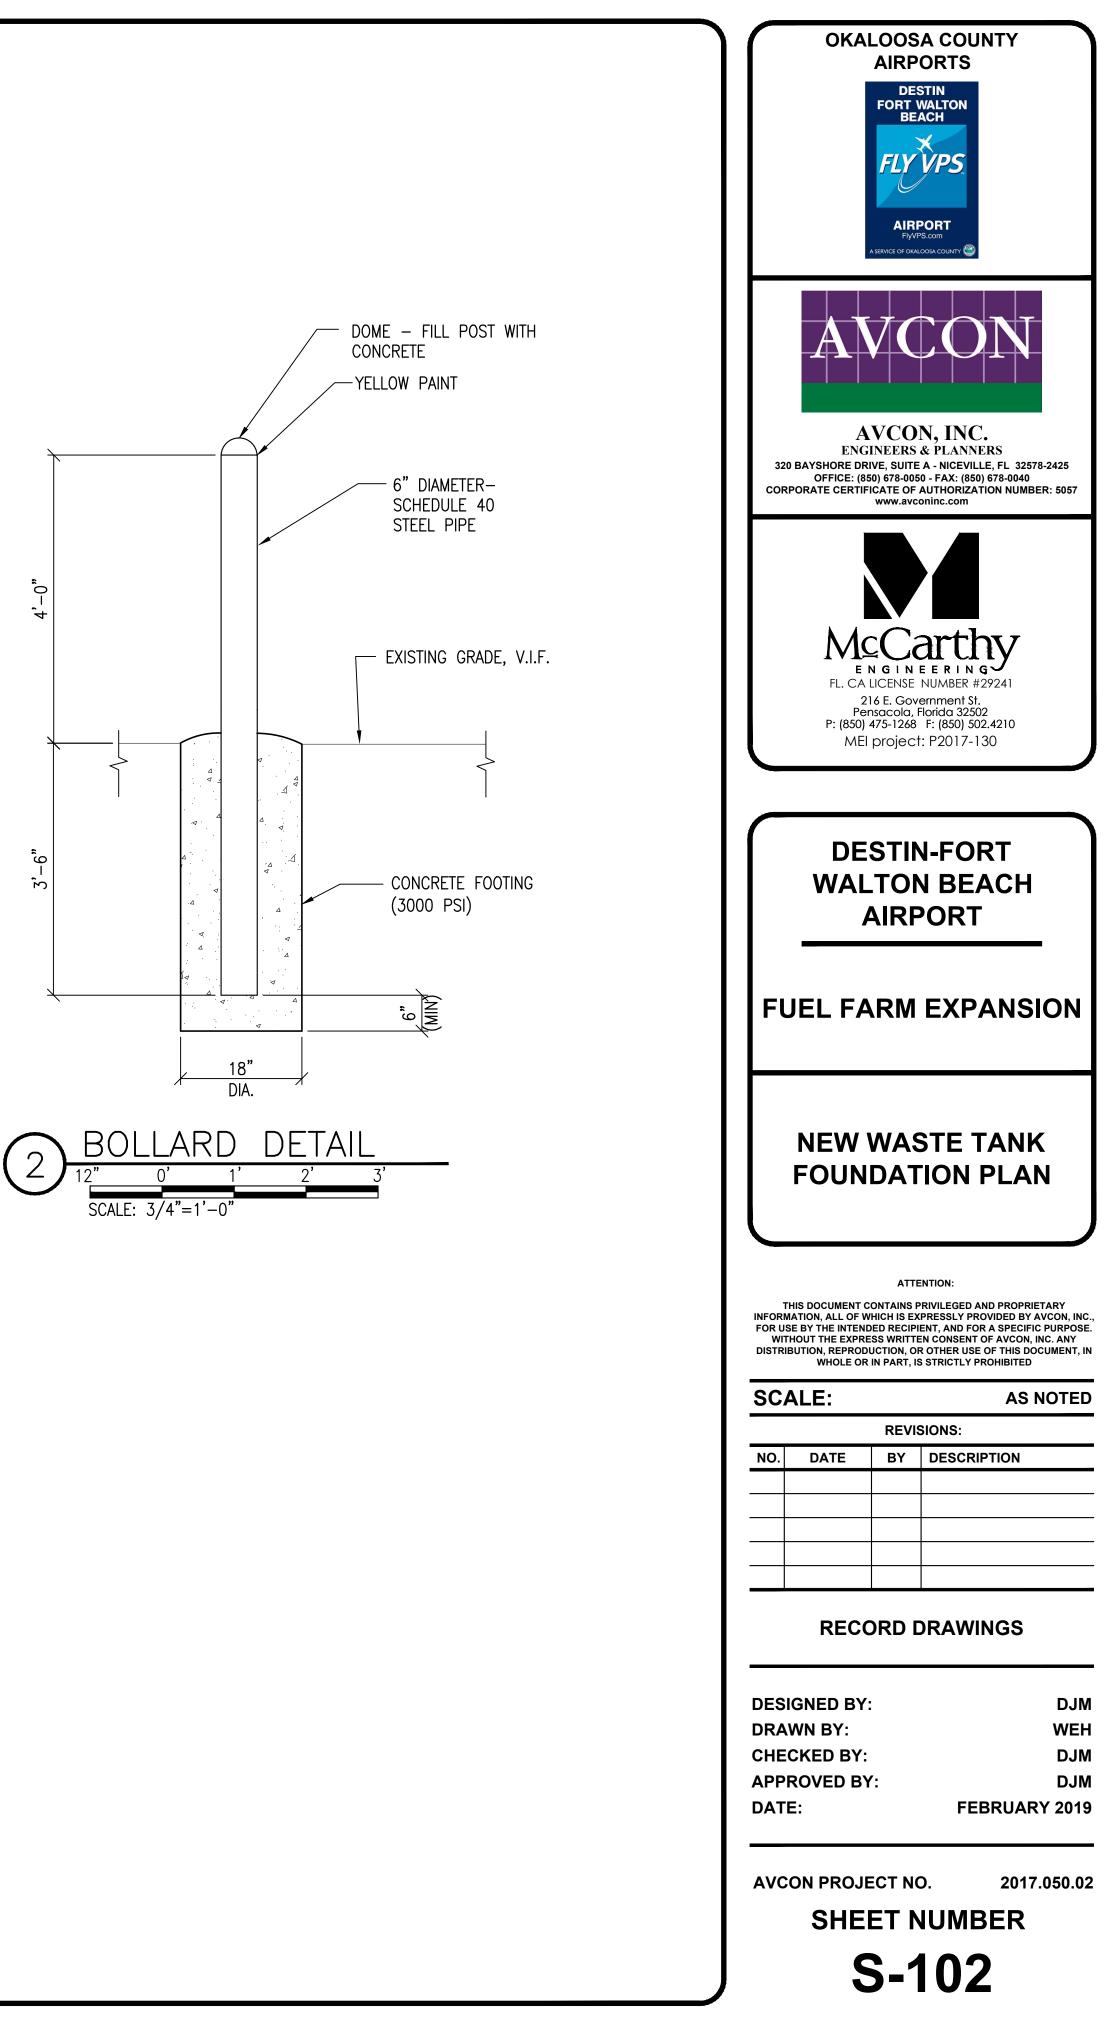

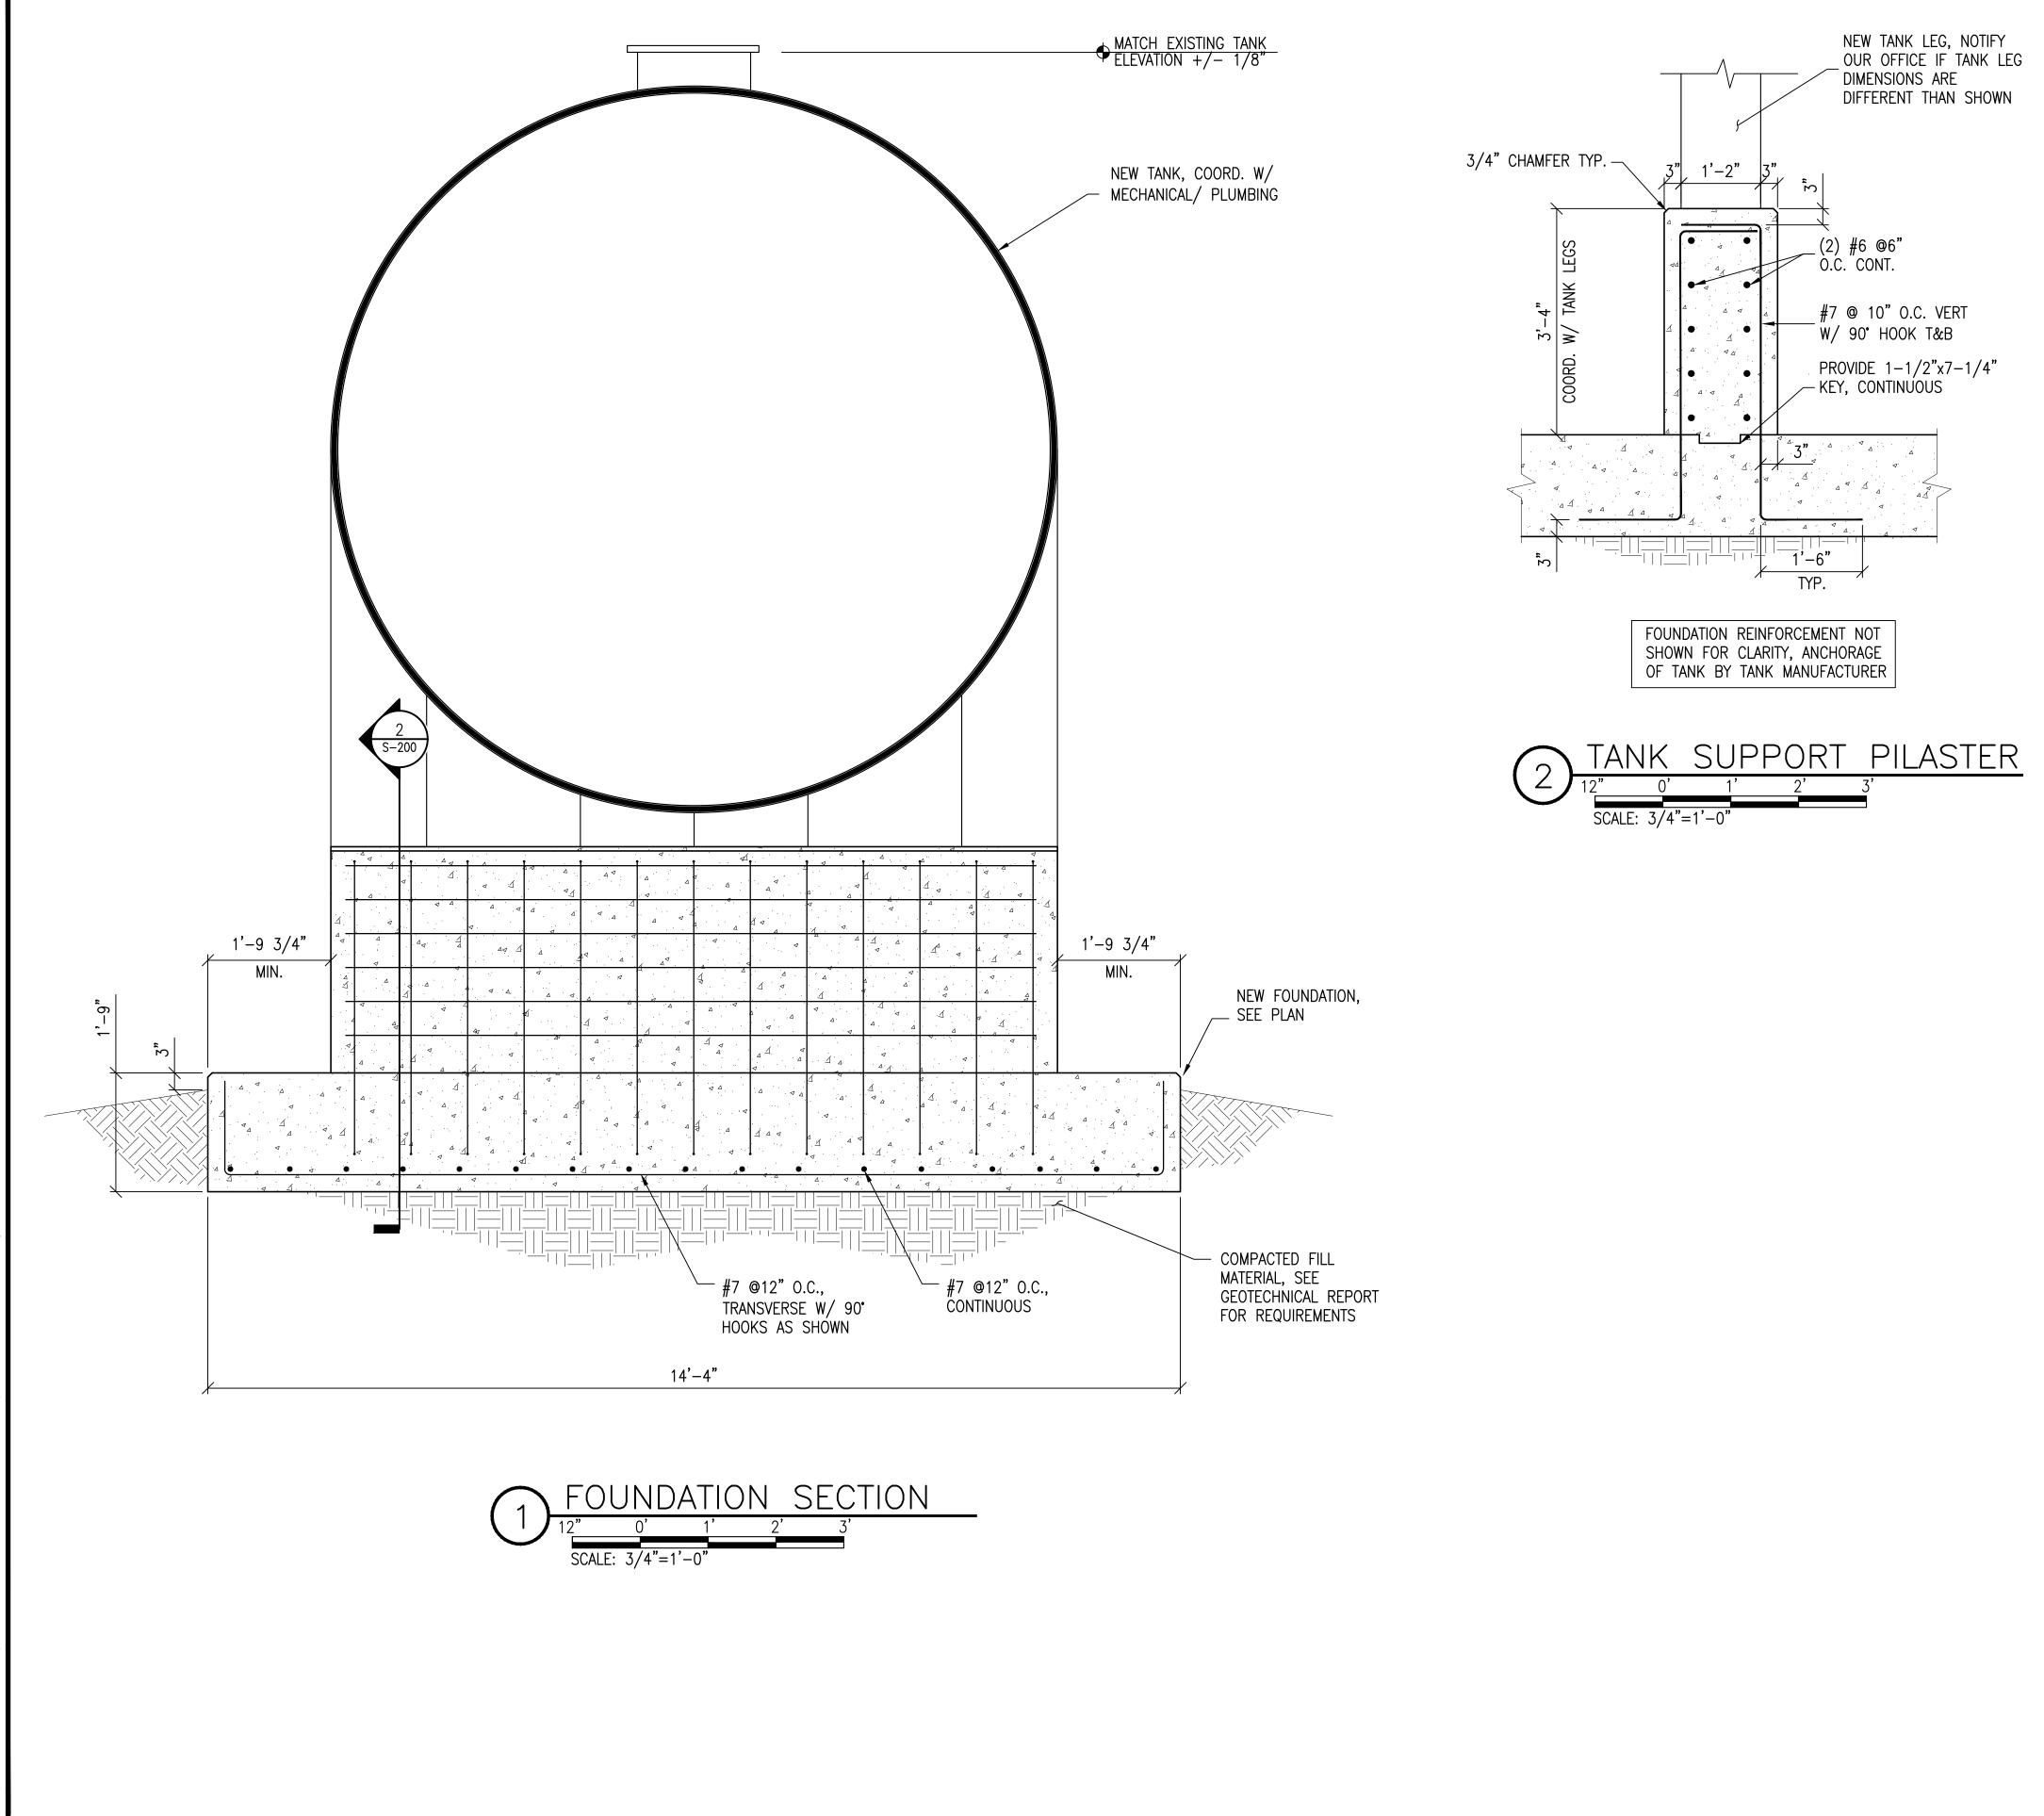


:\2017 Project\2017-130 VPS fuel farm\drawings february 7, 2019




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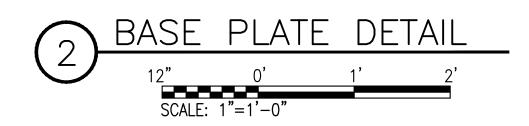
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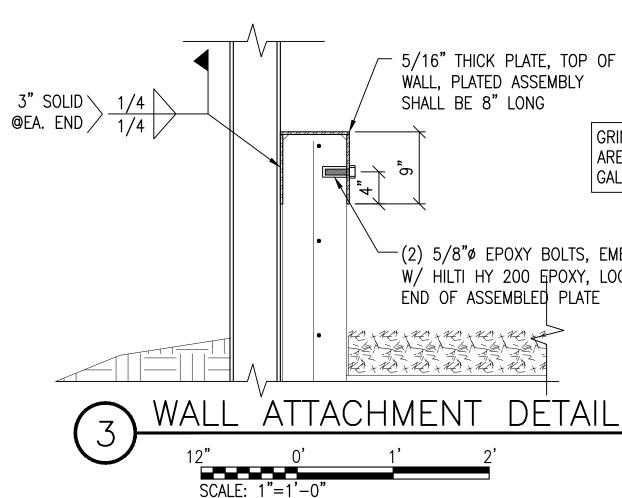
SHEET NUMBER



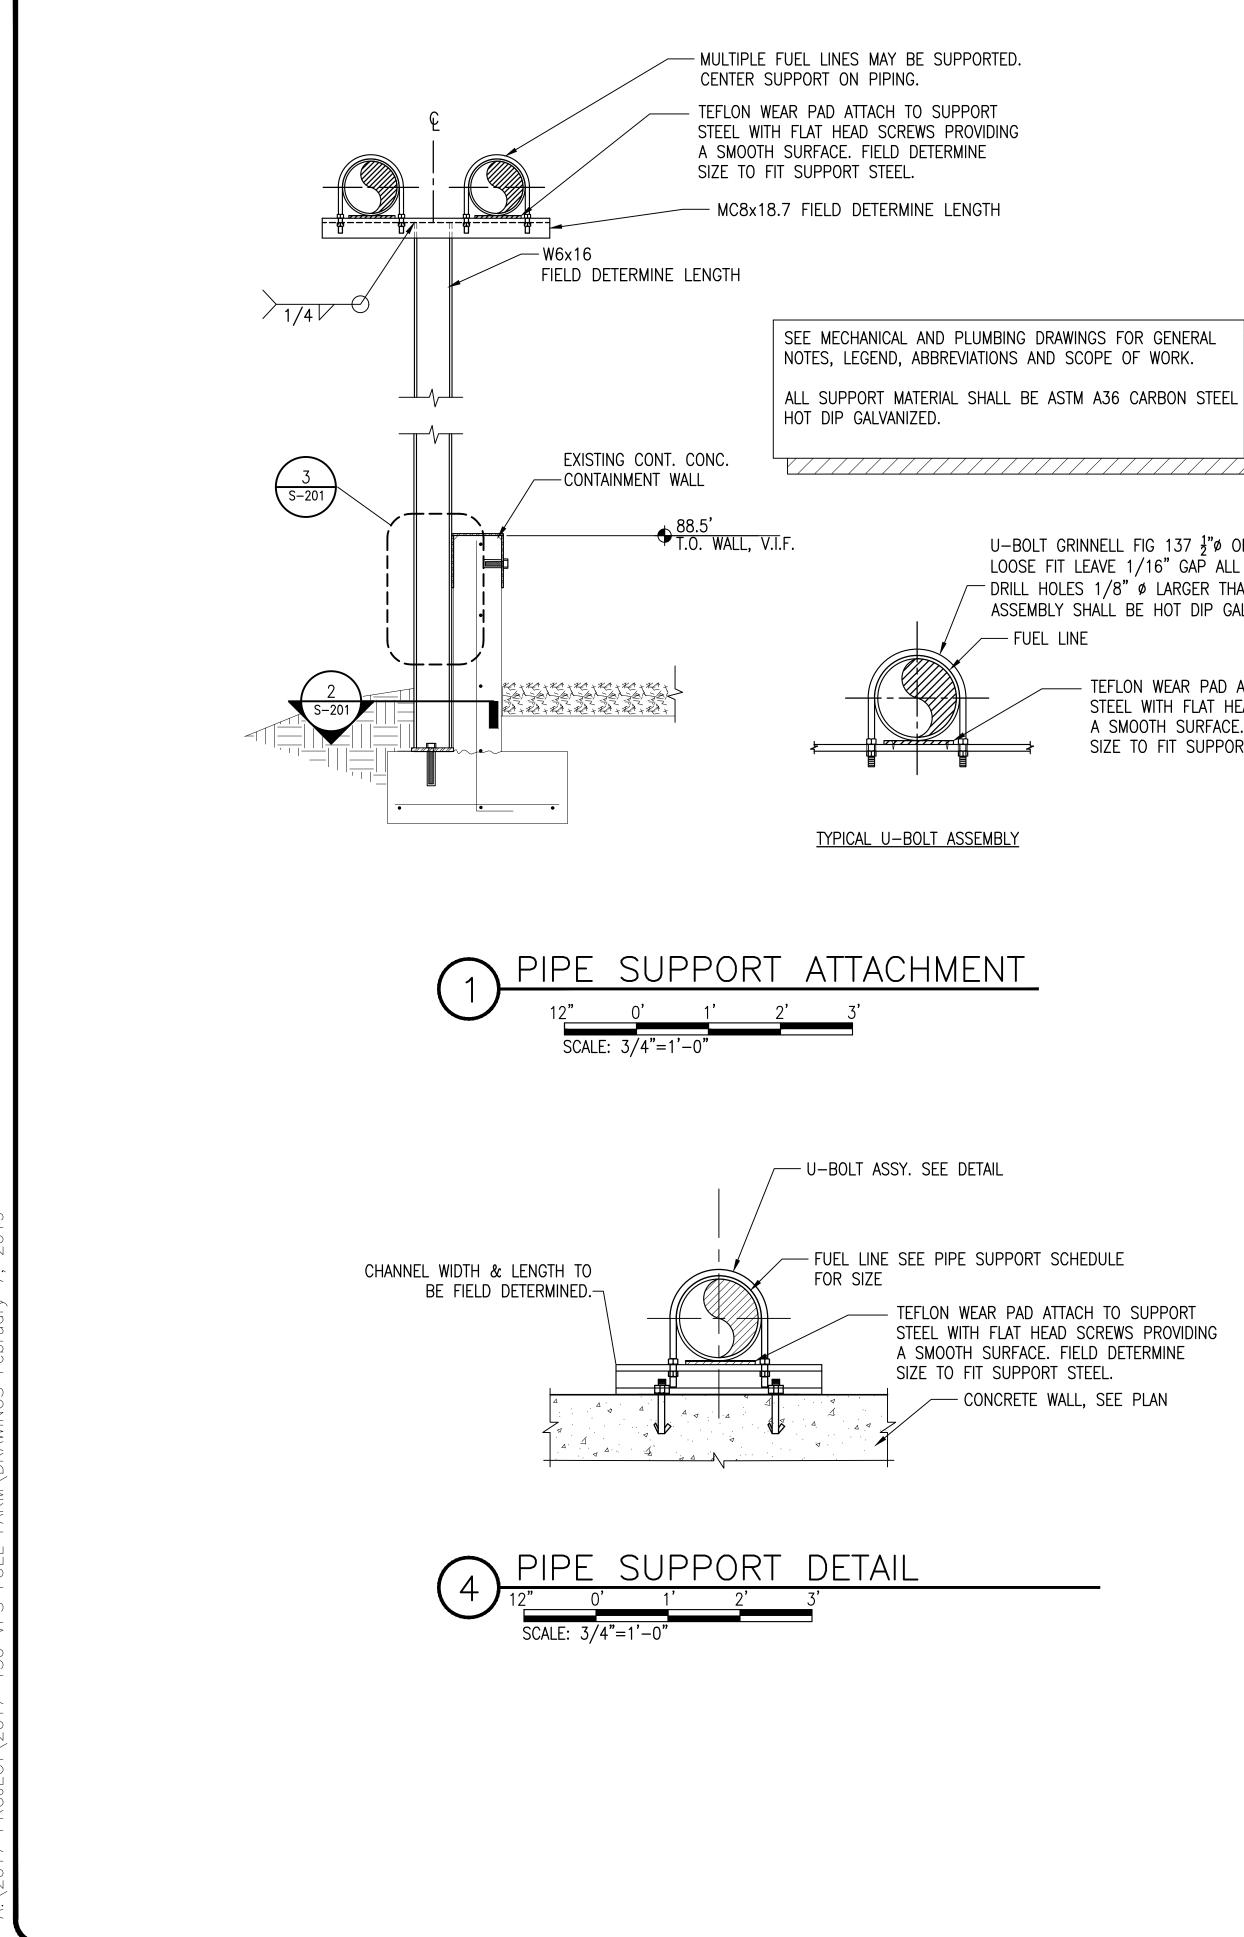

3/4"ø EPOXY BOLT, EMBED 5" INTO EXISTING CONCRETE FOUNDATION AND SET W/ HILTI HY 200 EPOXY OR APPROVED EQUIVALENT

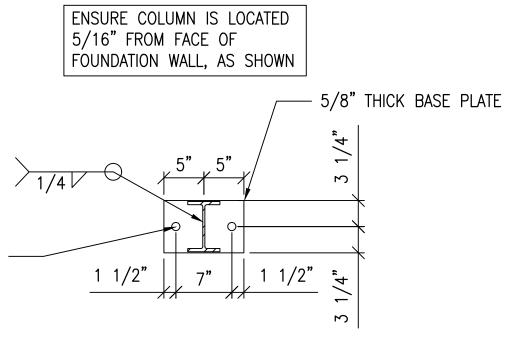




U–BOLT GRINNELL FIG 137  $\frac{1}{2}$ "Ø OR EQUAL LOOSE FIT LEAVE 1/16" GAP ALL AROUND - DRILL HOLES 1/8" Ø LARGER THAN U-BOLT. ASSEMBLY SHALL BE HOT DIP GALVANIZED

> TEFLON WEAR PAD ATTACH TO SUPPORT STEEL WITH FLAT HEAD SCREWS PROVIDING A SMOOTH SURFACE. FIELD DETERMINE SIZE TO FIT SUPPORT STEEL.

GRIND GALVANIZATION FROM WELDED AREAS. AFTER WELDING COLD GALVANIZE PAINT WELDED AREA.


 $\sim$  (2) 5/8" Ø EPOXY BOLTS, EMBED 3" AND SET W/ HILTI HY 200 EPOXY, LOCATE 2" FROM

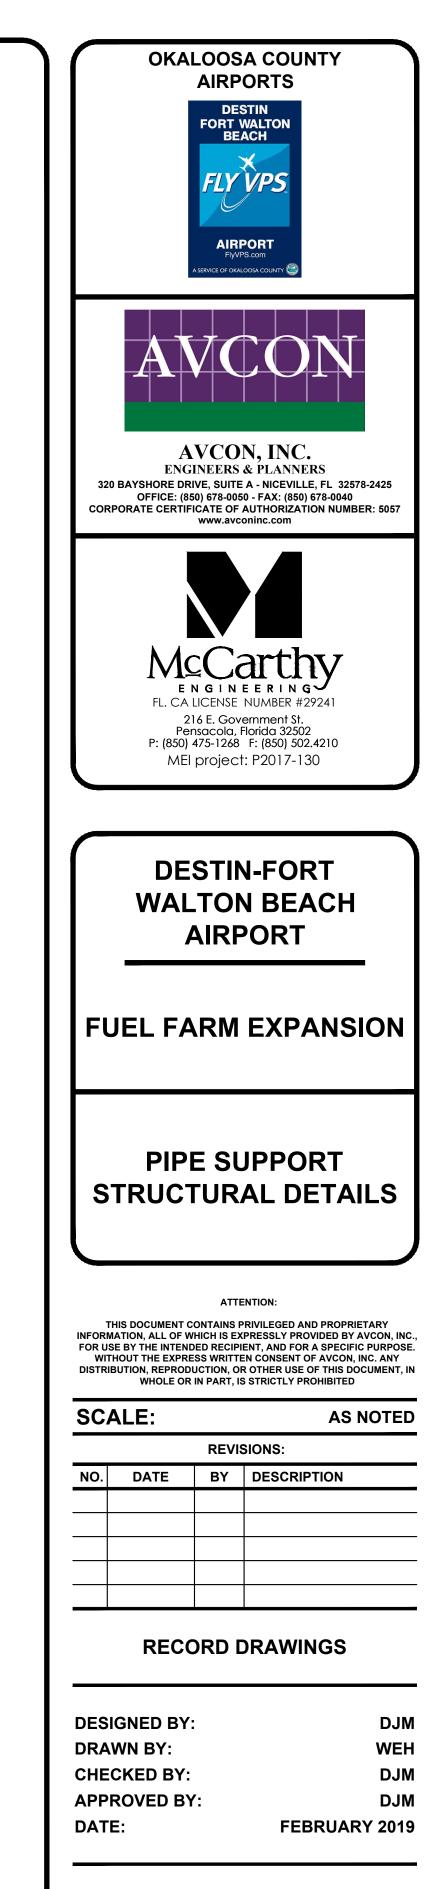


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2017.050.02

SHEET NUMBER



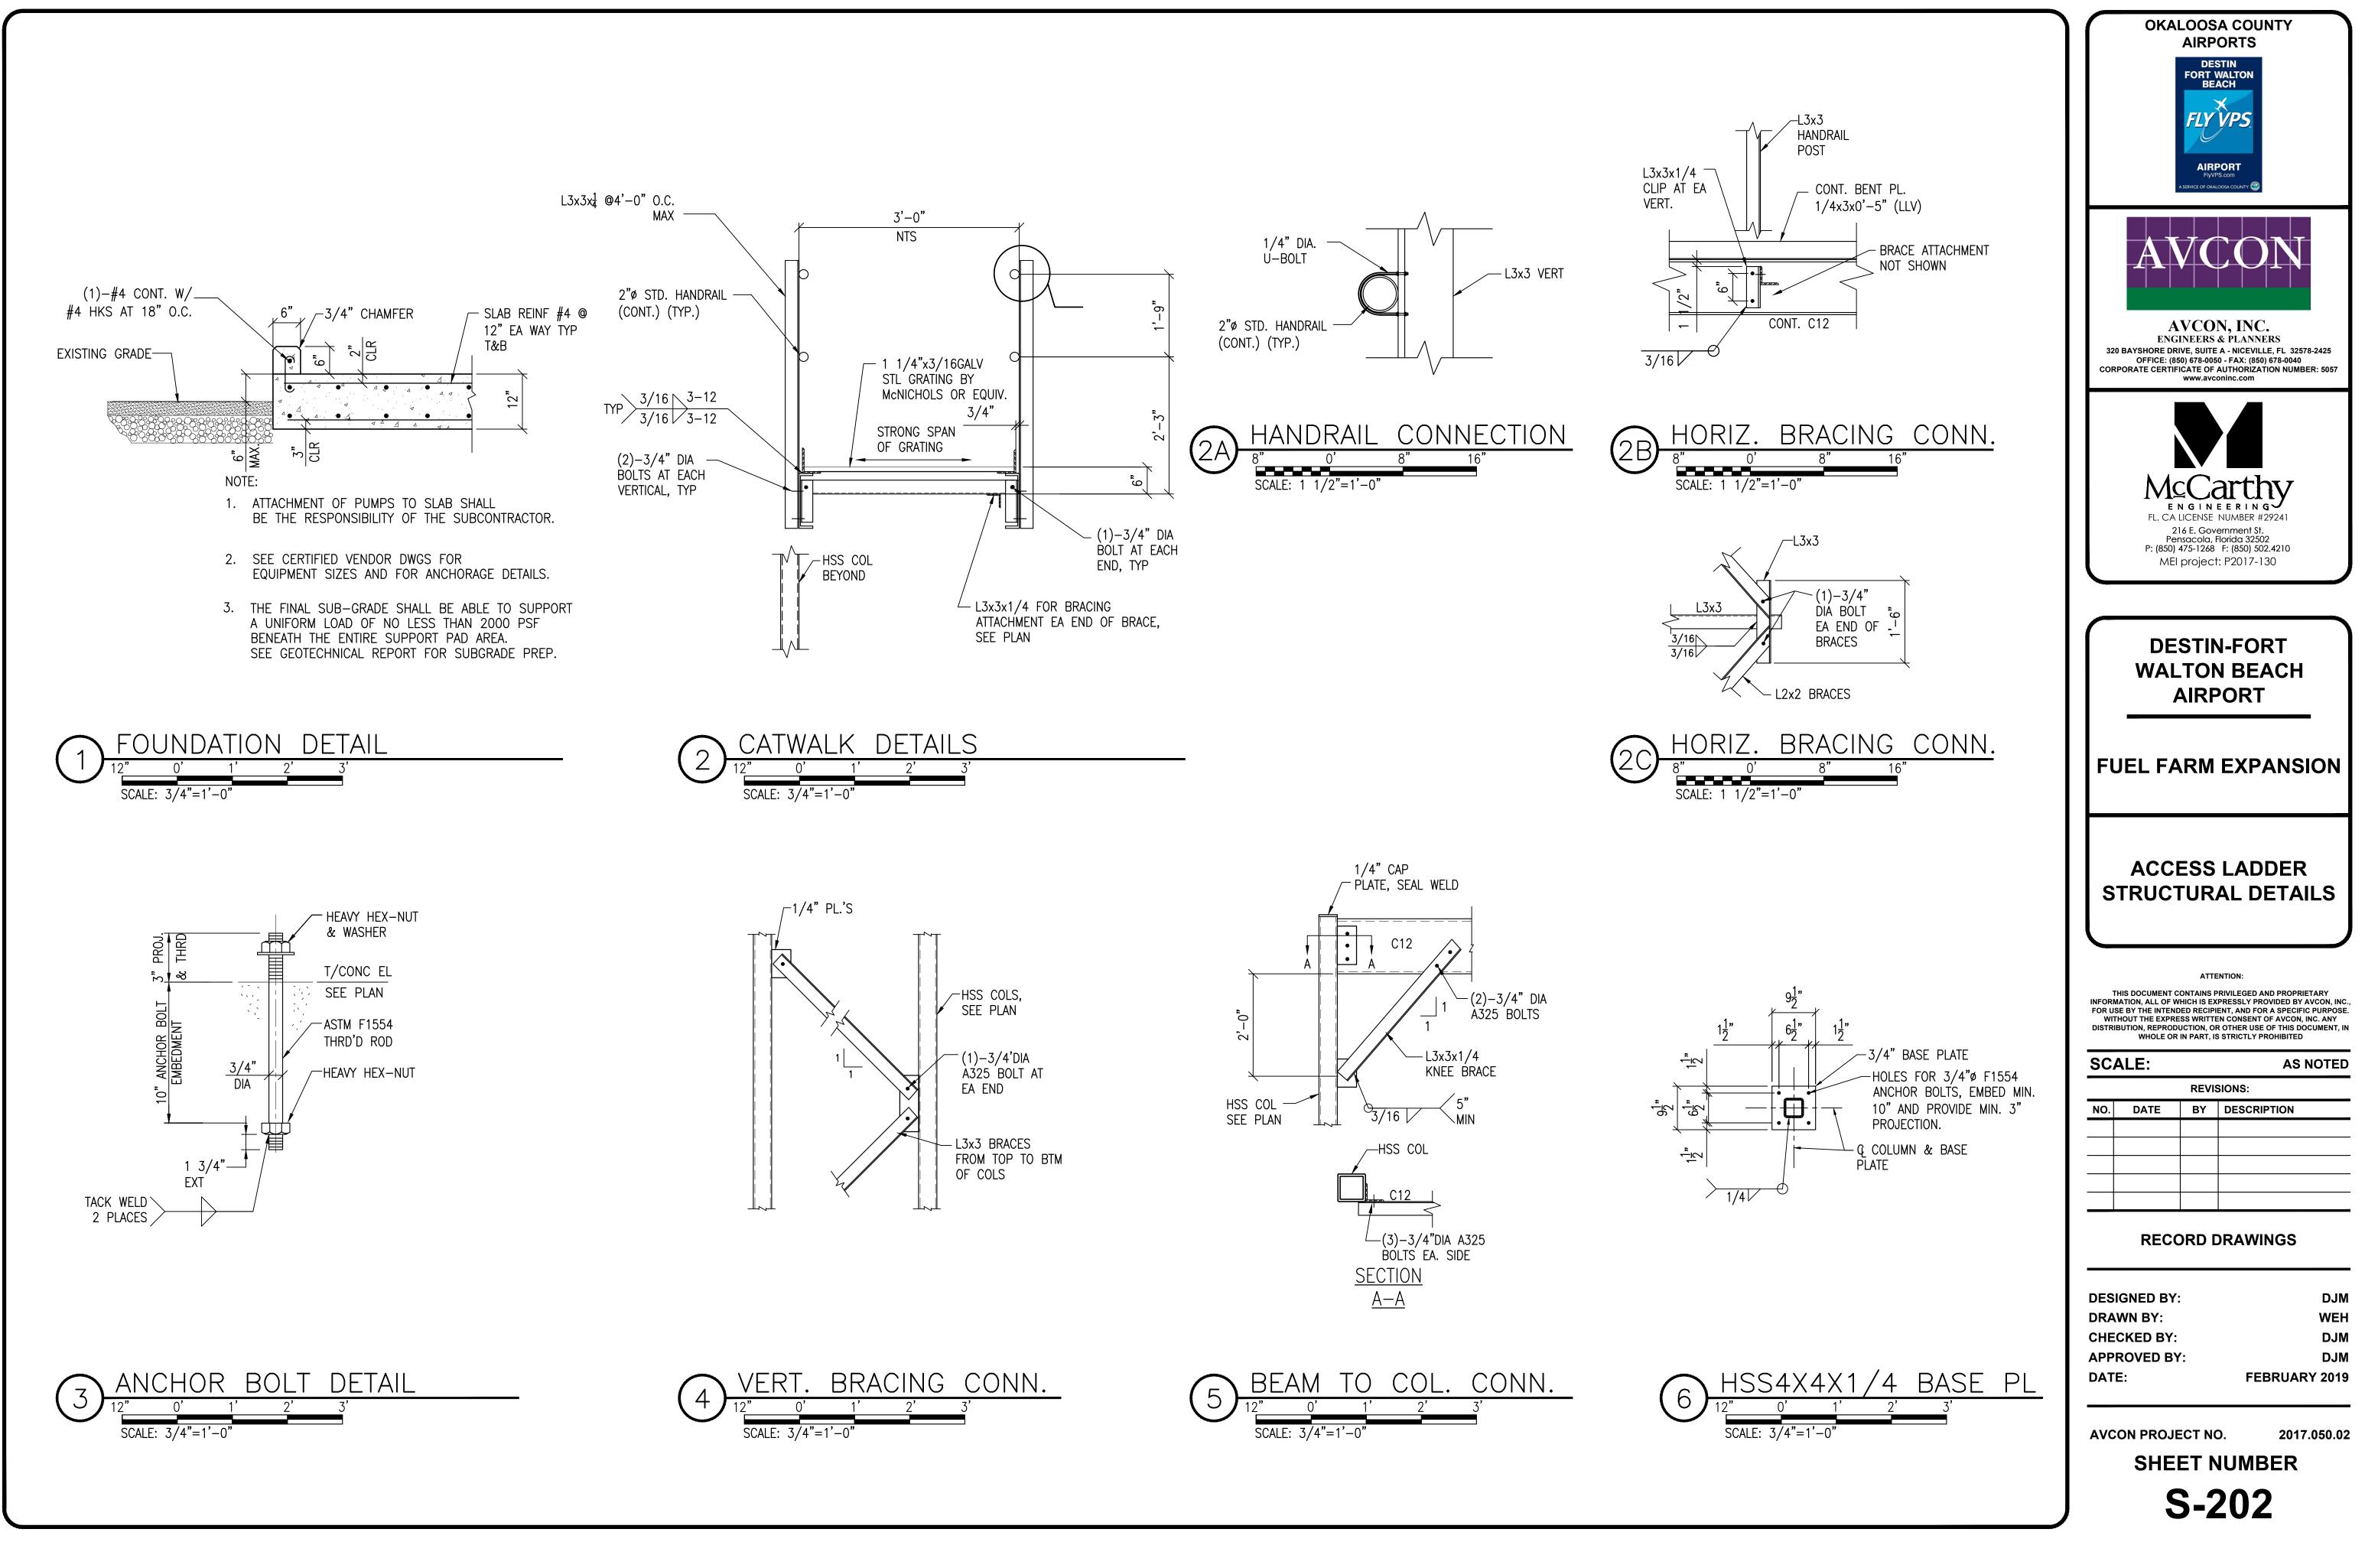

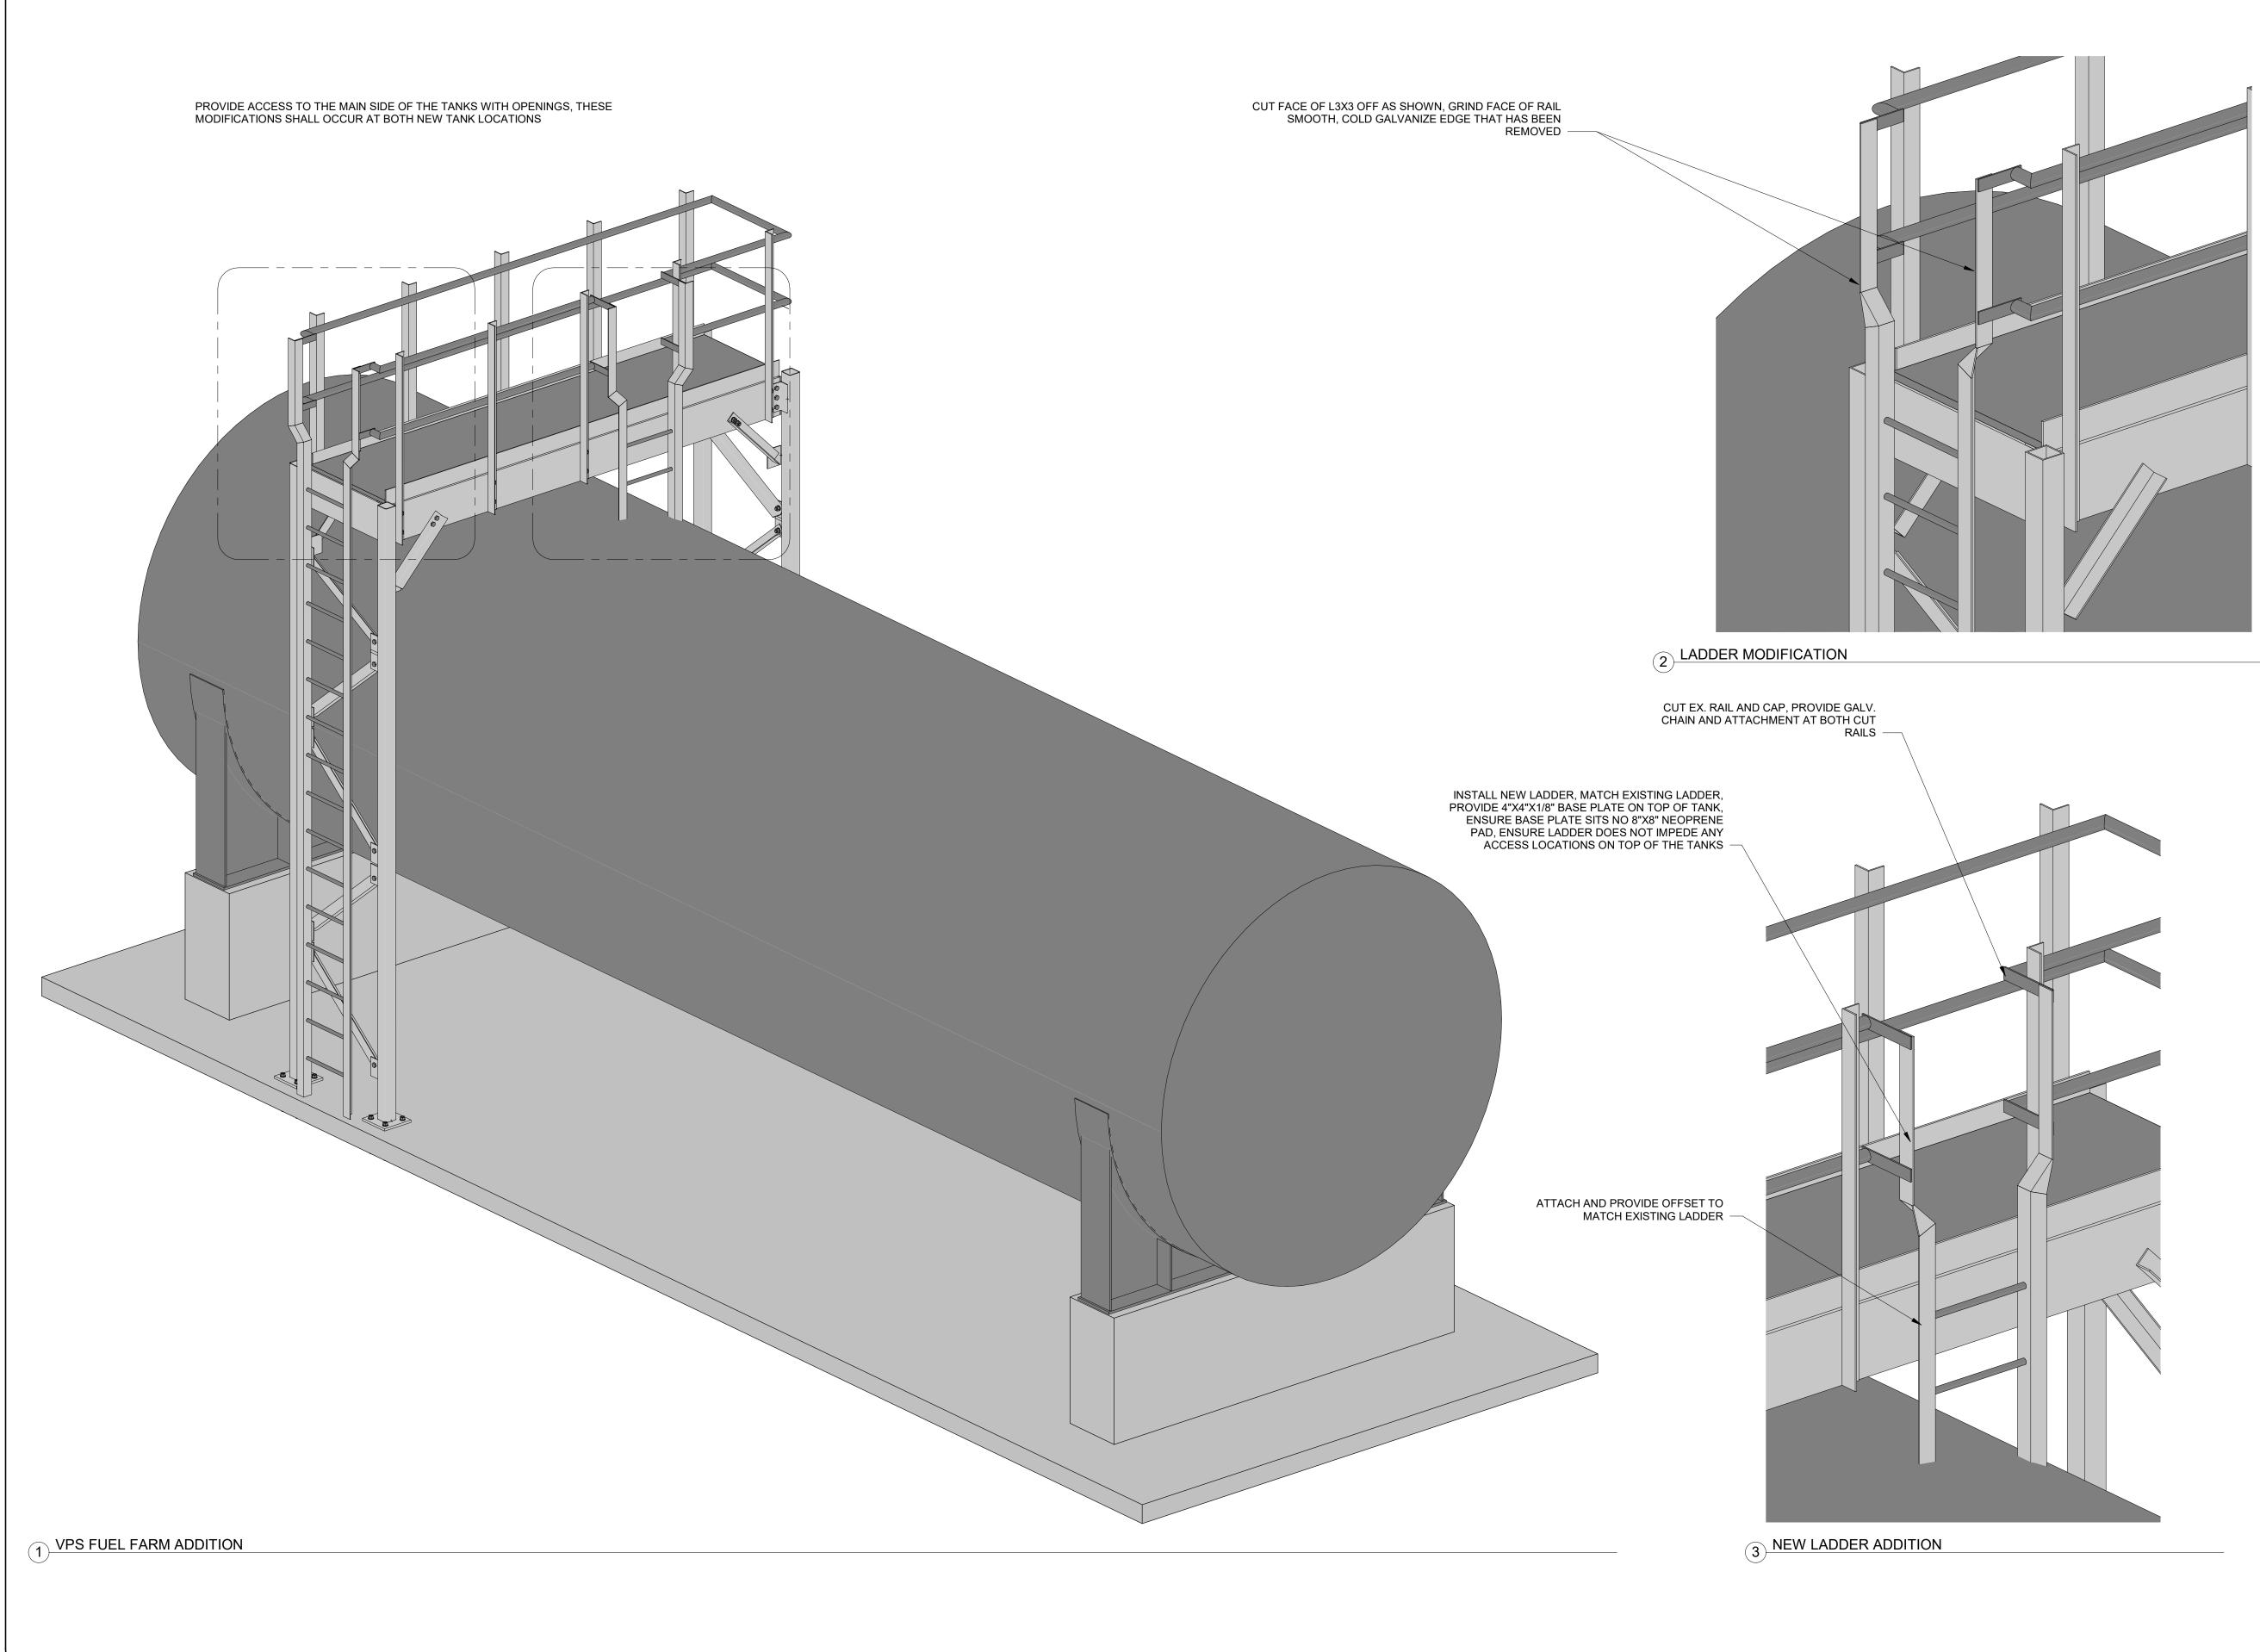

SHEET NUMBER

DESIGNED BY: DJM WEH DRAWN BY: CHECKED BY: DJM DJM APPROVED BY: FEBRUARY 2019 DATE:

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SCALE:			
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NO.	DATE	BY	DESCRIPTION

**RECORD DRAWINGS** 

SCALE.

# STRUCTURAL SKETCH

**DESTIN-FORT** WALTON BEACH AIRPORT

OKALOOSA COUNTY AIRPORTS

DESTIN FORT WALTON BEACH

× FLY VPS

AIRPORT FlyVPS.com


AVCON, INC. Engineers & planners

320 BAYSHORE DRIVE, SUITE A - NICEVILLE, FL 32578-2425 OFFICE: (850) 678-0050 - FAX: (850) 678-0040 CORPORATE CERTIFICATE OF AUTHORIZATION NUMBER: 5057 www.avconinc.com

McCarthy ENGINEERING FL. CALICENSE NUMBER #29241

216 E. Government St. Pensacola, Florida 32502 P: (850) 475-1268 F: (850) 502-4210 MEI project: 2017-130

# FUEL FARM EXPANSION

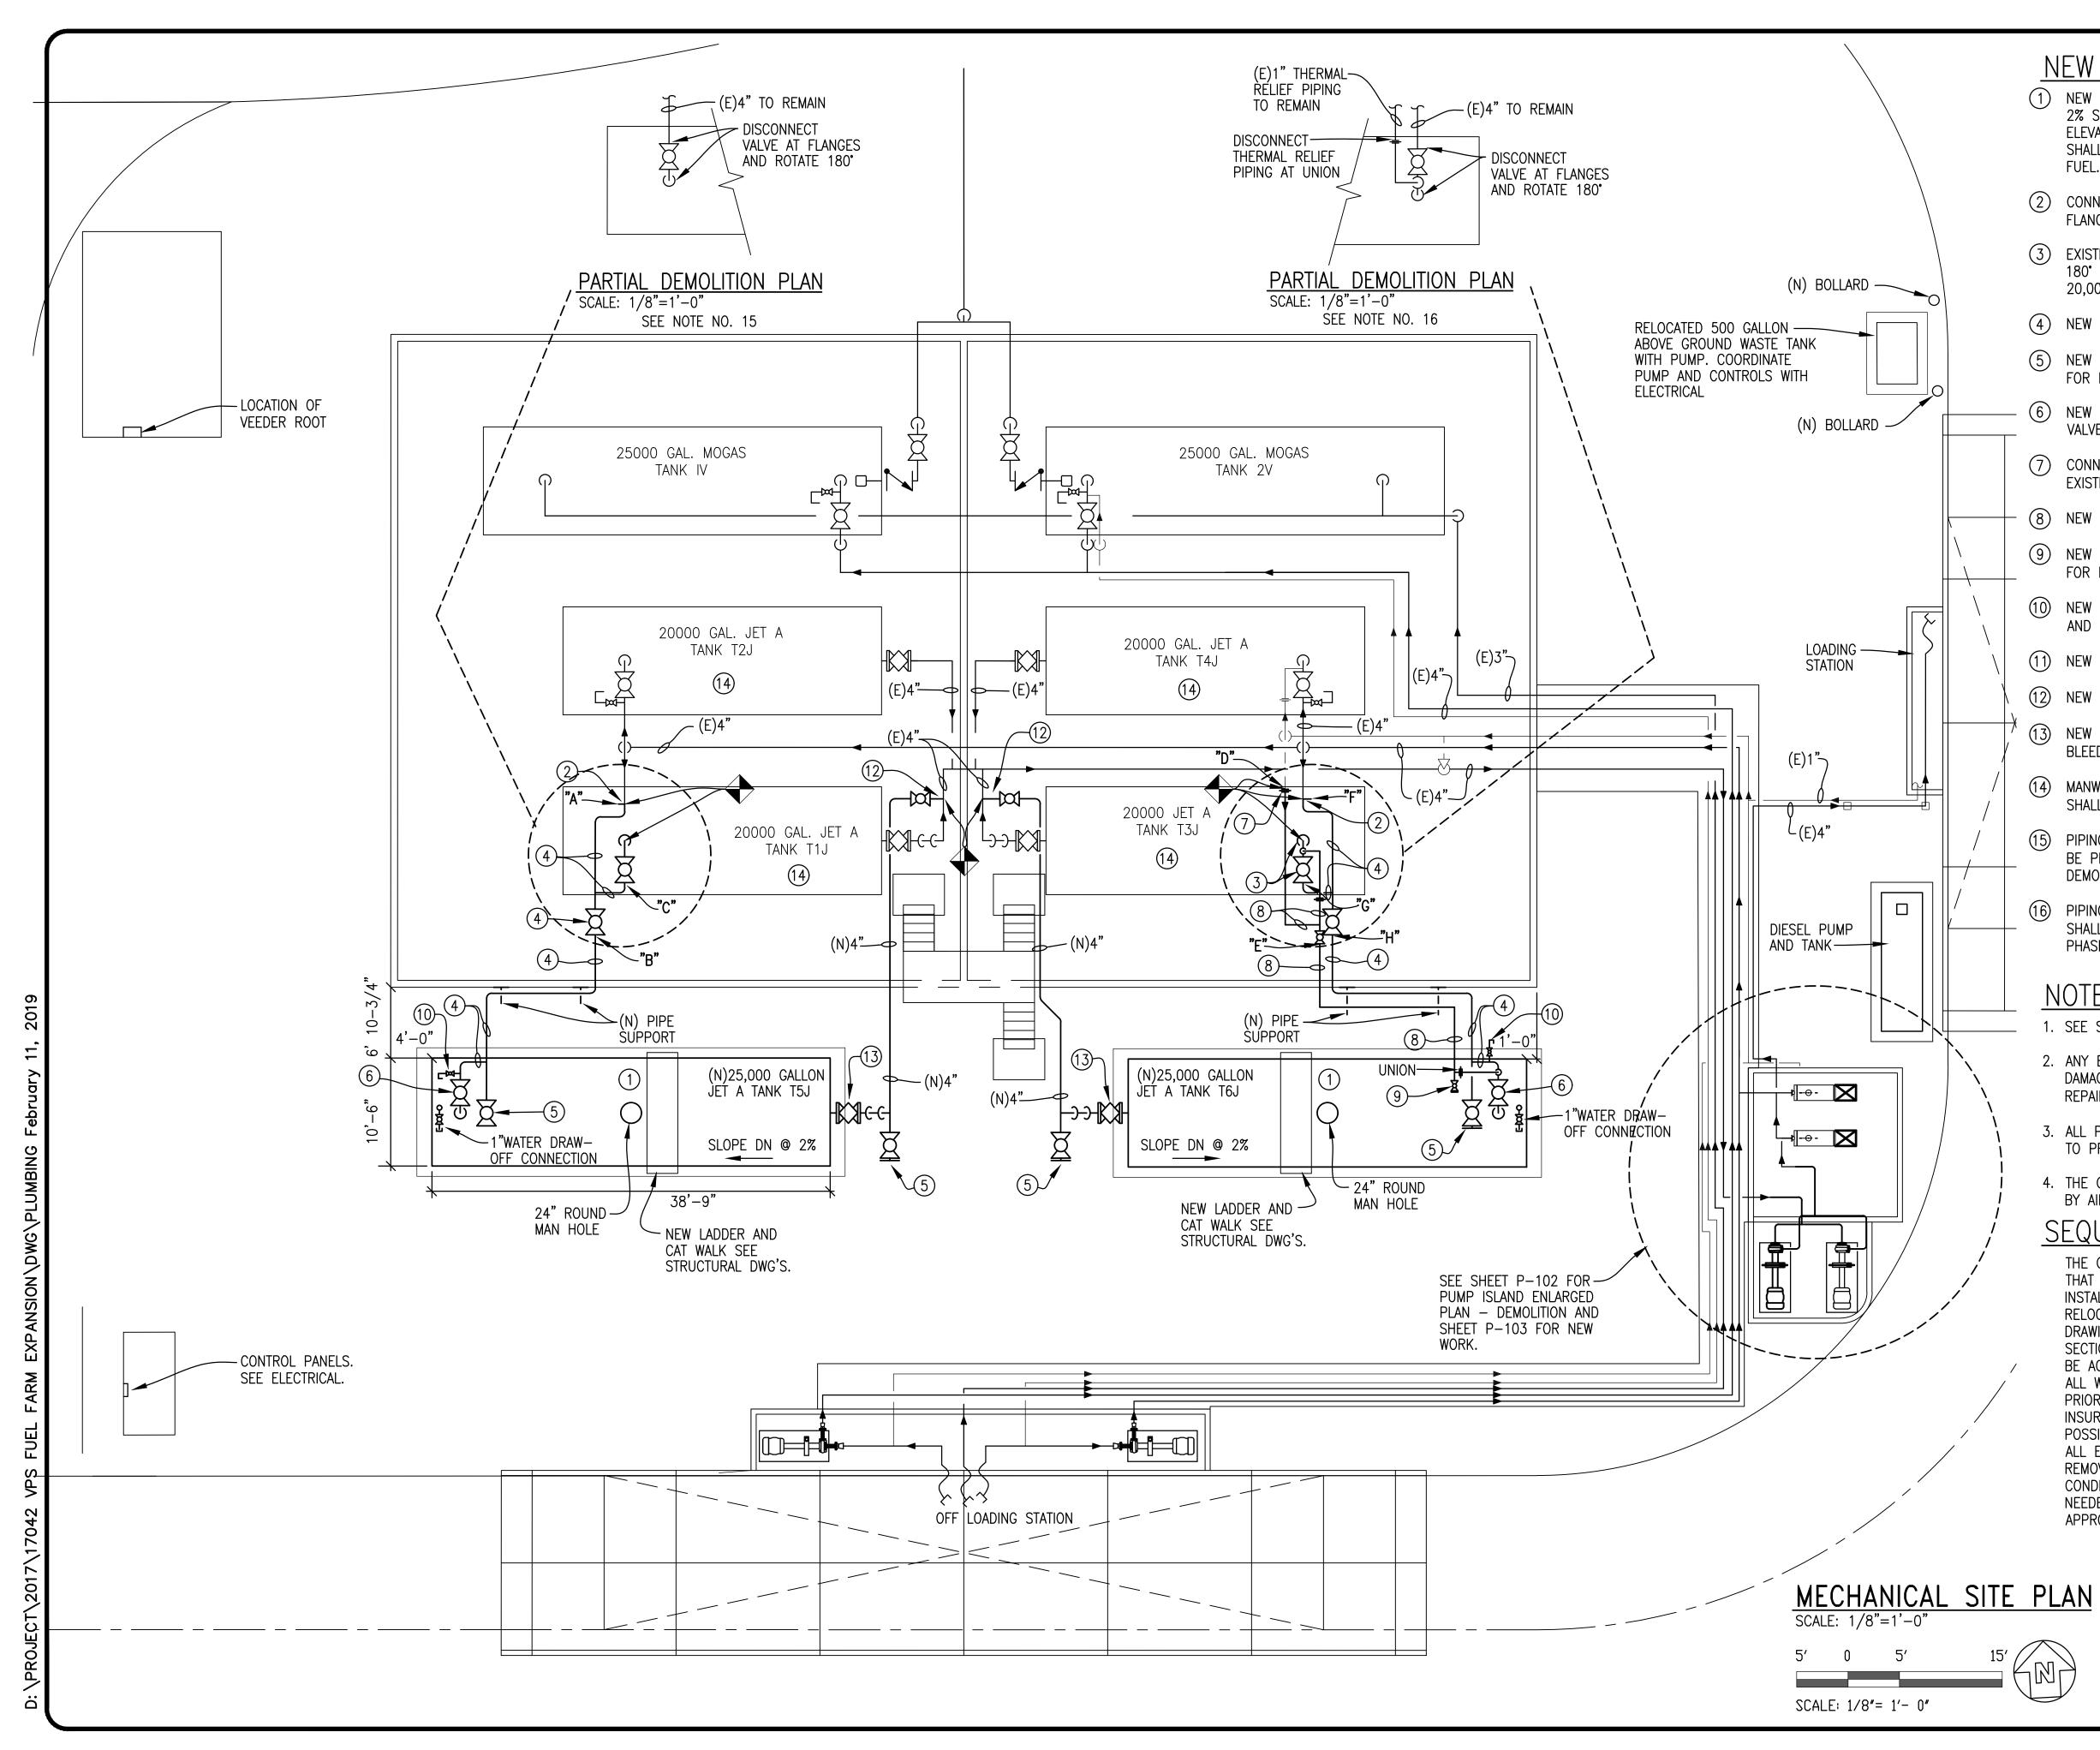

# NEW MODE NOTES

N	EW WORK NOTES:	
1	NEW JET A 25,000 GALLON TANK SET AT A 2% SLOPE TO DRAIN AND AT SAME ELEVATION AS EXISTING JET A TANKS. TANK SHALL BE INTERNALLY COATED FOR JET A FUEL.	
2	CONNECT NEW 4" PIPING TO EXISTING 4" AT FLANGE.	
3	EXISTING VALVE AND PIPING ROTATED AT 180° AND RECONNECTED TO EXISTING 20,000 GALLON JET A TANK.	
4	NEW 4" PIPING.	
5	NEW 4" BALL VALVE WITH BLIND FLANGE FOR FUTURE CONNECTION.	
6	NEW 120 VOLT ELECTRIC OPERATED BALL VALVE.	
7	CONNECT NEW 1" THERMAL RELIEF LINE TO EXISTING AT UNION.	
8	NEW 1" THERMAL RELIEF PIPING.	
9	NEW 1" BALL VALVE WITH BLIND FLANGE FOR FUTURE.	
10	NEW 1" MANUAL AIR VENT WITH BALL VALVE AND CAP.	
(11)	NEW 4" BALL VALVE FOR SERVICE.	
(12)	NEW 4" HOT TAP WITH 4" TAPPING VALVE.	
(13)	NEW 4" PLUG VALVE. DOUBLE BLOCK AND BLEED.	
(14)	MANWAY OF EXISTING JET A FUEL TANK (4) SHALL BE COATED.	
(15)	PIPING BETWEEN "A", "B", AND "C" SHALL BE PREFABRICATED BEFORE THIS PHASE OF DEMOLITION.	
(16)	PIPING BETWEEN "D", "E", "F", "G" AND "H" SHALL BE PREFABRICATED BEFORE THIS PHASE OF DEMOLITION.	
N	OTES:	
1. SEE SHEET P-105 FOR GENERAL NOTES.		
_		

- 2. ANY EXISTING PIPING OR EQUIPMENT DAMAGED DURING CONSTRUCTION SHALL BE REPAIRED TO IT'S ORIGINAL FINISH.
- 3. ALL PIPES AND METAL SHALL BE PAINTED TO PROTECT FROM RUST.
- 4. THE CRANE LOCATION SHALL BE APPROVED BY AIRPORT PERSONAL.

# SEQUENCE OF WORK:

THE OVERALL SEQUENCE OF THE WORK IS THAT THE NEW PUMP P-7 SHALL BE INSTALLED AND OPERATIONAL BEFORE THE RELOCATION OF EXISTING PUMP P-3. THE DRAWING INDICATES SPECIFIC PIPING SECTIONS AND TIE-IN POINTS FOR THIS TO BE ACCOMPLISHED. ALL WORK WHICH CAN BE COMPLETED PRIOR TO SHUT DOWN SHALL BE DONE TO INSURE THE SHORTEST DOWN TIME POSSIBLE. ALL EQUIPMENT AND PIPING BEING REMOVED SHALL BE MAINTAINED IN GOOD CONDITION TO BE ABLE TO BE REUSED IF NEEDED UNTIL ALL SYSTEMS HAVE BEEN APPROVED BY OWNER.



**OKALOOSA COUNTY** 

PETERSON ENGINEERING INC. (PROF. ENG. **#**: 3600) 75 SOUTH "F" STREET PENSACOLA, FLORIDA 32502 (850) 434–0513 P.E.I. JOB# 17042

# **DESTIN-FORT** WALTON BEACH AIRPORT

# FUEL FARM EXPANSION

# **MECHANICAL SITE** PLAN

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SCALE:			AS NOTED		
	REVISIONS:				
NO.	DATE	BY	DESCRIPTION		

### **RECORD DRAWINGS**

DESIGNED BY:	J.R.C.
DRAWN BY:	S.M.M.
CHECKED BY:	J.R.C.
APPROVED BY:	V.C.L.
DATE:	FEBRUARY 2019

AVCON PROJECT NO.


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# **DEMOLITION NOTES:**

- (1) 500 GALLON ABOVE GROUND WASTE TANK TO BE RELOCATED COMPLETE WITH PUMP.
- $\langle 2 \rangle$  DISCONNECT PIPING AT FLANGE BELOW BETWEEN PIPING AND VALVE.
- $\overline{\langle 3 \rangle}$  DISCONNECT 1" THERMAL RELIEF LINE AT FLANGE.
- (4) DISCONNECT 1" FILL LINE AT FLANGE IN VERTICAL PIPING ABOVE VALVE.
- $\langle 5 \rangle$  DISCONNECT PIPING AT FLANGE.
- 6 REMOVE 4" VALVE AND SPOOL PIECE AND RETAIN ON SITE UNTIL NEW PUMP IS IN SERVICE.
- $\langle 7 \rangle$  REMOVE SECTION OF 4" PIPING AND RETAIN ON SITE UNTIL NEW PIPING AND PUMP ARE IN SERVICE.
- $\langle 8 \rangle$  PUMP P-3 TO BE RELOCATED COMPLETE WITH FLEX CONNECTIONS, ALL ATTACHED COMPONENTS AND CONTROLS.

# NOTES:

- 1. SEE NEW WORK NOTE NO. 10 ON SHEET P-103 BEFORE ANY DEMOLITION.
- 2. SEE SHEET P-105 FOR GENERAL NOTES.
- 3. ANY EXISTING PIPING OR EQUIPMENT DAMAGED DURING CONSTRUCTION SHALL BE REPAIRED TO IT'S ORIGINAL FINISH.

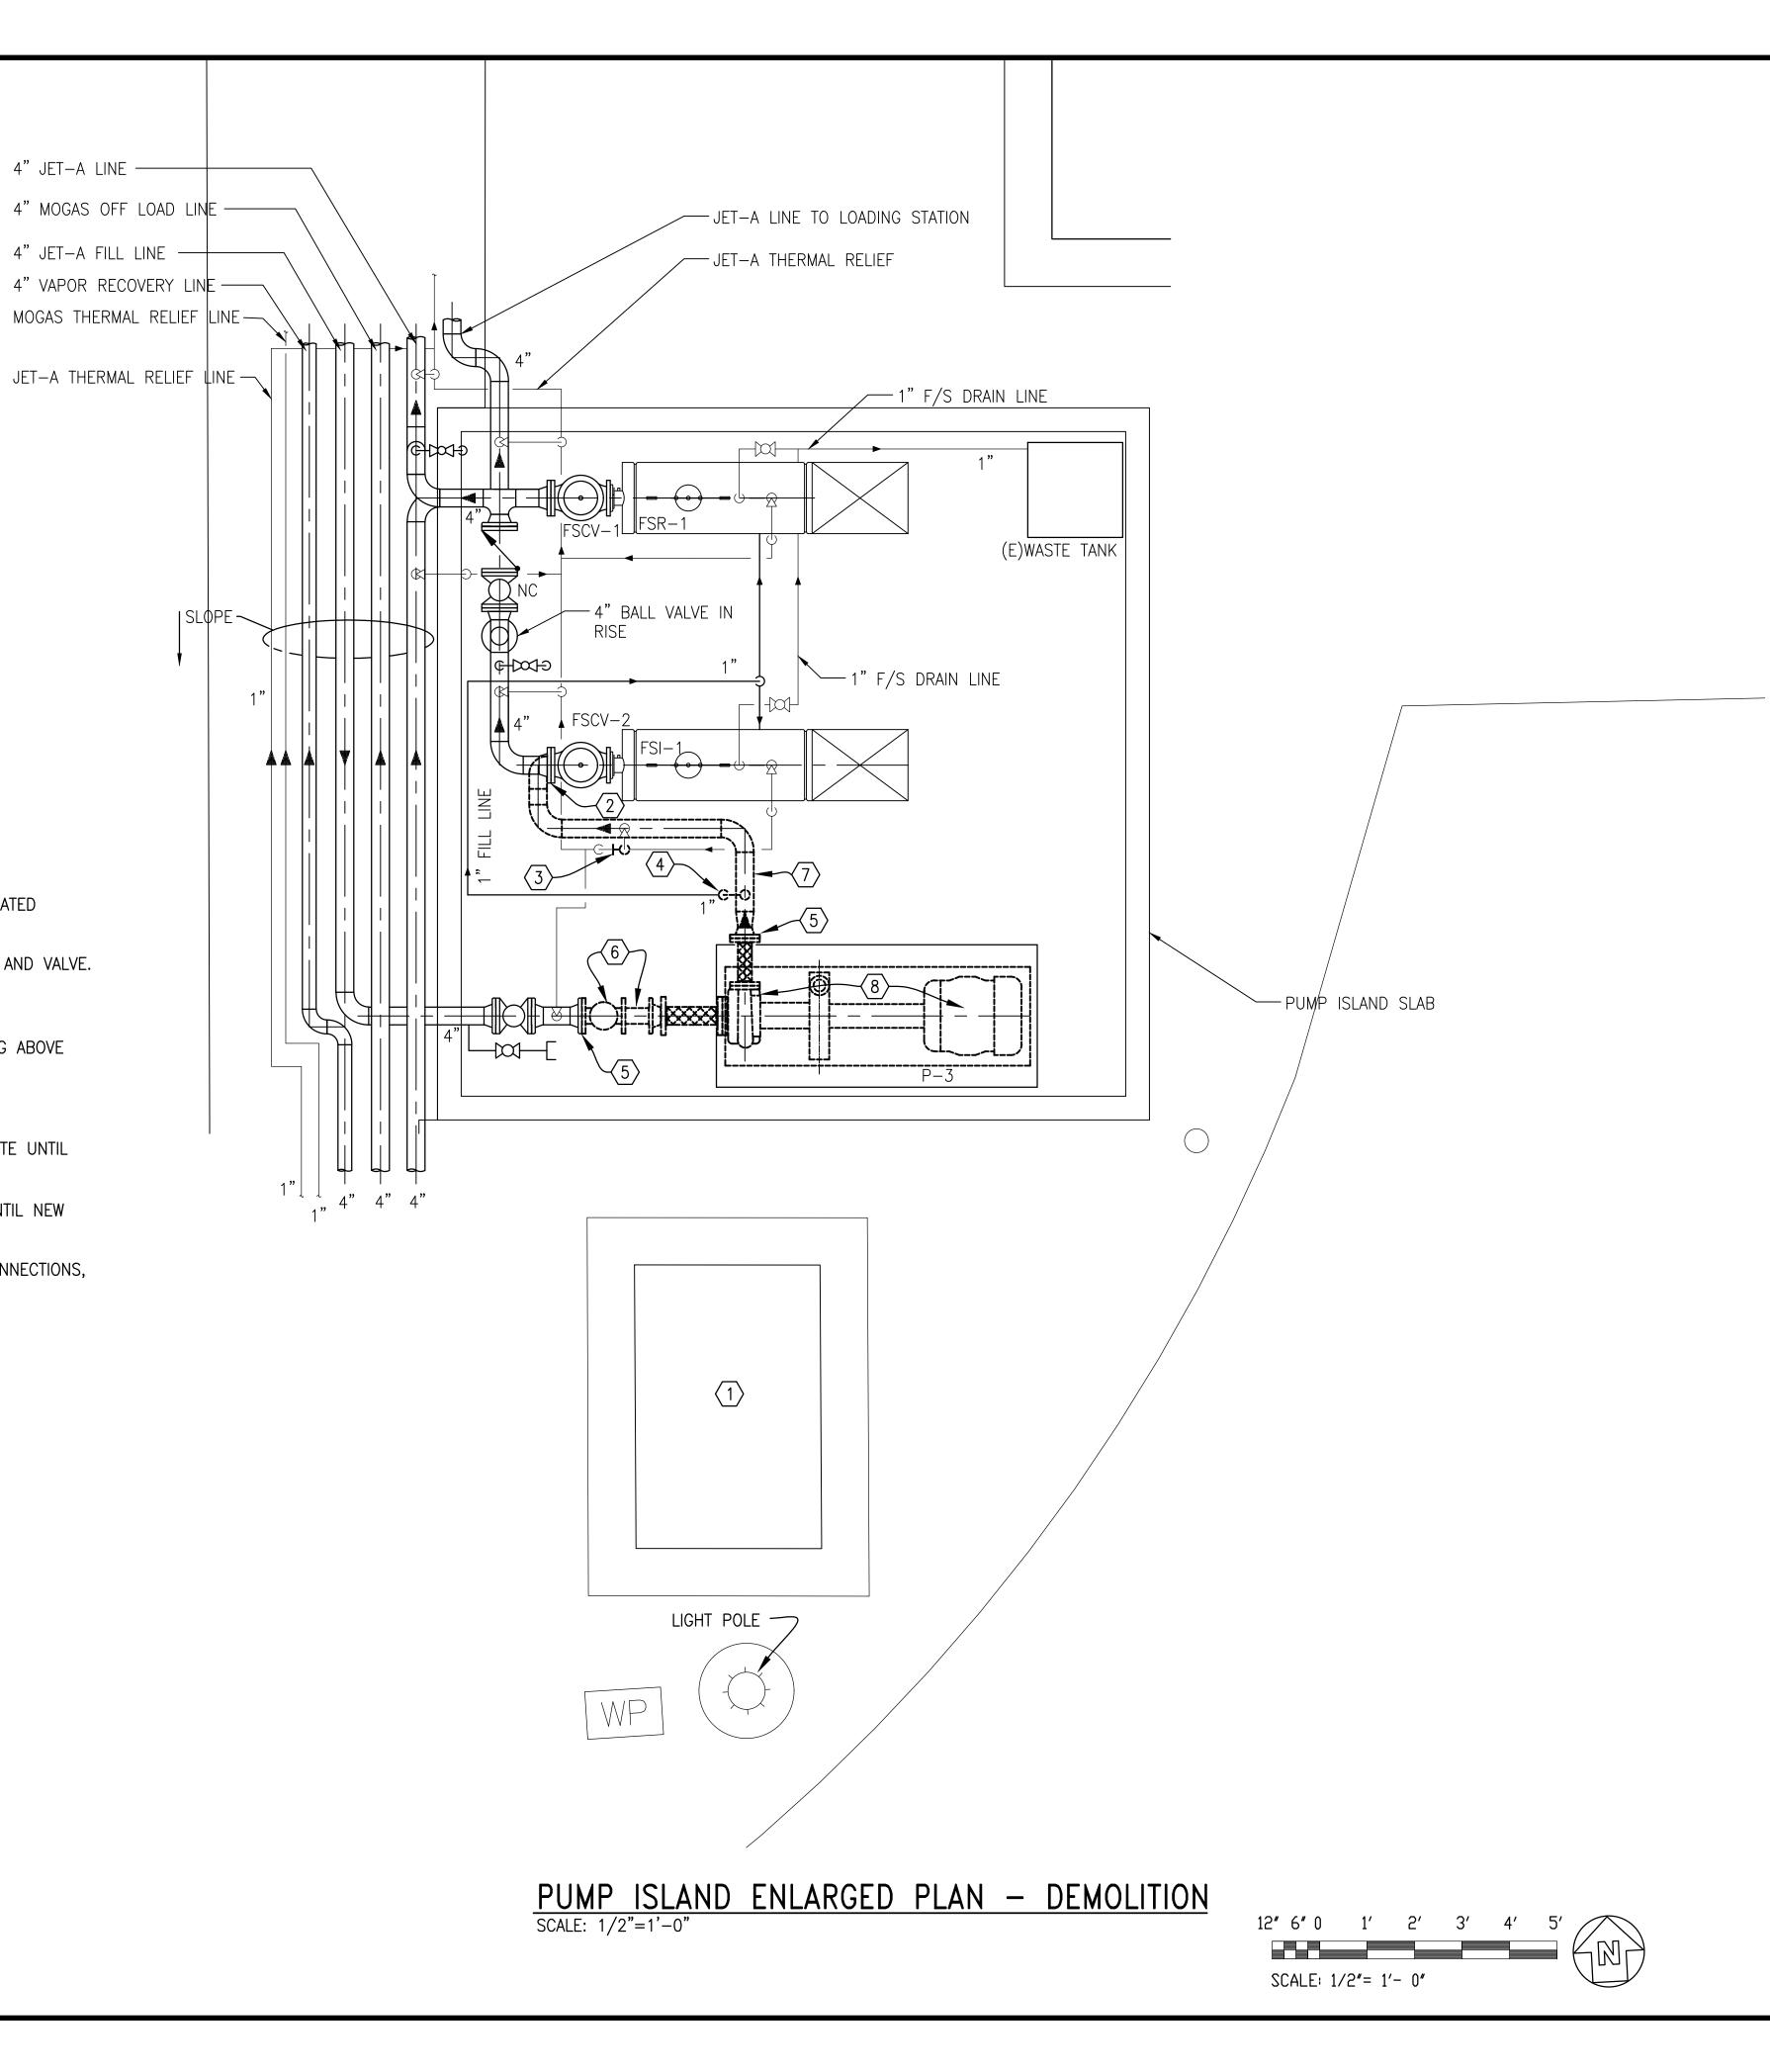

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DESIGNED BY:	J.R.C.
DRAWN BY:	S.M.M.
CHECKED BY:	J.R.C.
APPROVED BY:	V.C.L.
DATE:	FEBRUARY 2019

AVCON PROJECT NO.

2017.050.02



(1) NEW CONCRETE PUMP BASE TO BE SET AT SAME ELEVATION AS OLD BASE.

4" JET-A LINE -----

4" MOGAS OFF LOAD LINE


4" JET-A FILL LINE -----

4" VAPOR RECOVERY LINE

- (2) SET NEW PUMP P-7 ON NEW CONCRETE BASE.
- (3) NEW FLEX CONNECTION.
- (4) NEW 4" PIPING AND BALL VALVES.
- 5 NEW 4" PIPE TO BE CONNECTED TO EXISTING BALL VALVE BELOW.
- 6 CONNECT NEW 1" JET A THERMAL RELIEF LINE TO EXISTING 1"FLANGE.
- (7) CONNECT NEW 1" FILL LINE AT FLANGE IN VERTICAL.
- (8) EXISTING PUMP P-3 TO BE RELOCATED TO THIS AREA. PUMP P-3 SHALL BE RELOCATED COMPLETELY.
- (9) FILTERS SHALL BE CHANGED AFTER STARTUP. SEE GENERAL NOTE NO. 11 ON SHEET P-105.
- $\bigcirc$  PUMP P-7 SHALL BE IN PLACE AND OPERATIONAL WITH PIPING SECTIONS BETWEEN "AA", "BB", "CC", "DD" AND CONNECTED TO PUMP P-7 SHALL BE IN PLACE WITH PIPING SECTIONS "AA" TO "EE" AND SECTION "BB" TO "FF" SHALL BE FABRICATED AND ON SITE BEFORE ANY DEMOLITION OF PUMP P-3.


# NOTES:

- 1. SEE SHEET P-105 FOR GENERAL NOTES.
- 2. ANY EXISTING PIPING OR EQUIPMENT DAMAGED DURING CONSTRUCTION SHALL BE REPAIRED TO IT'S ORIGINAL FINISH.

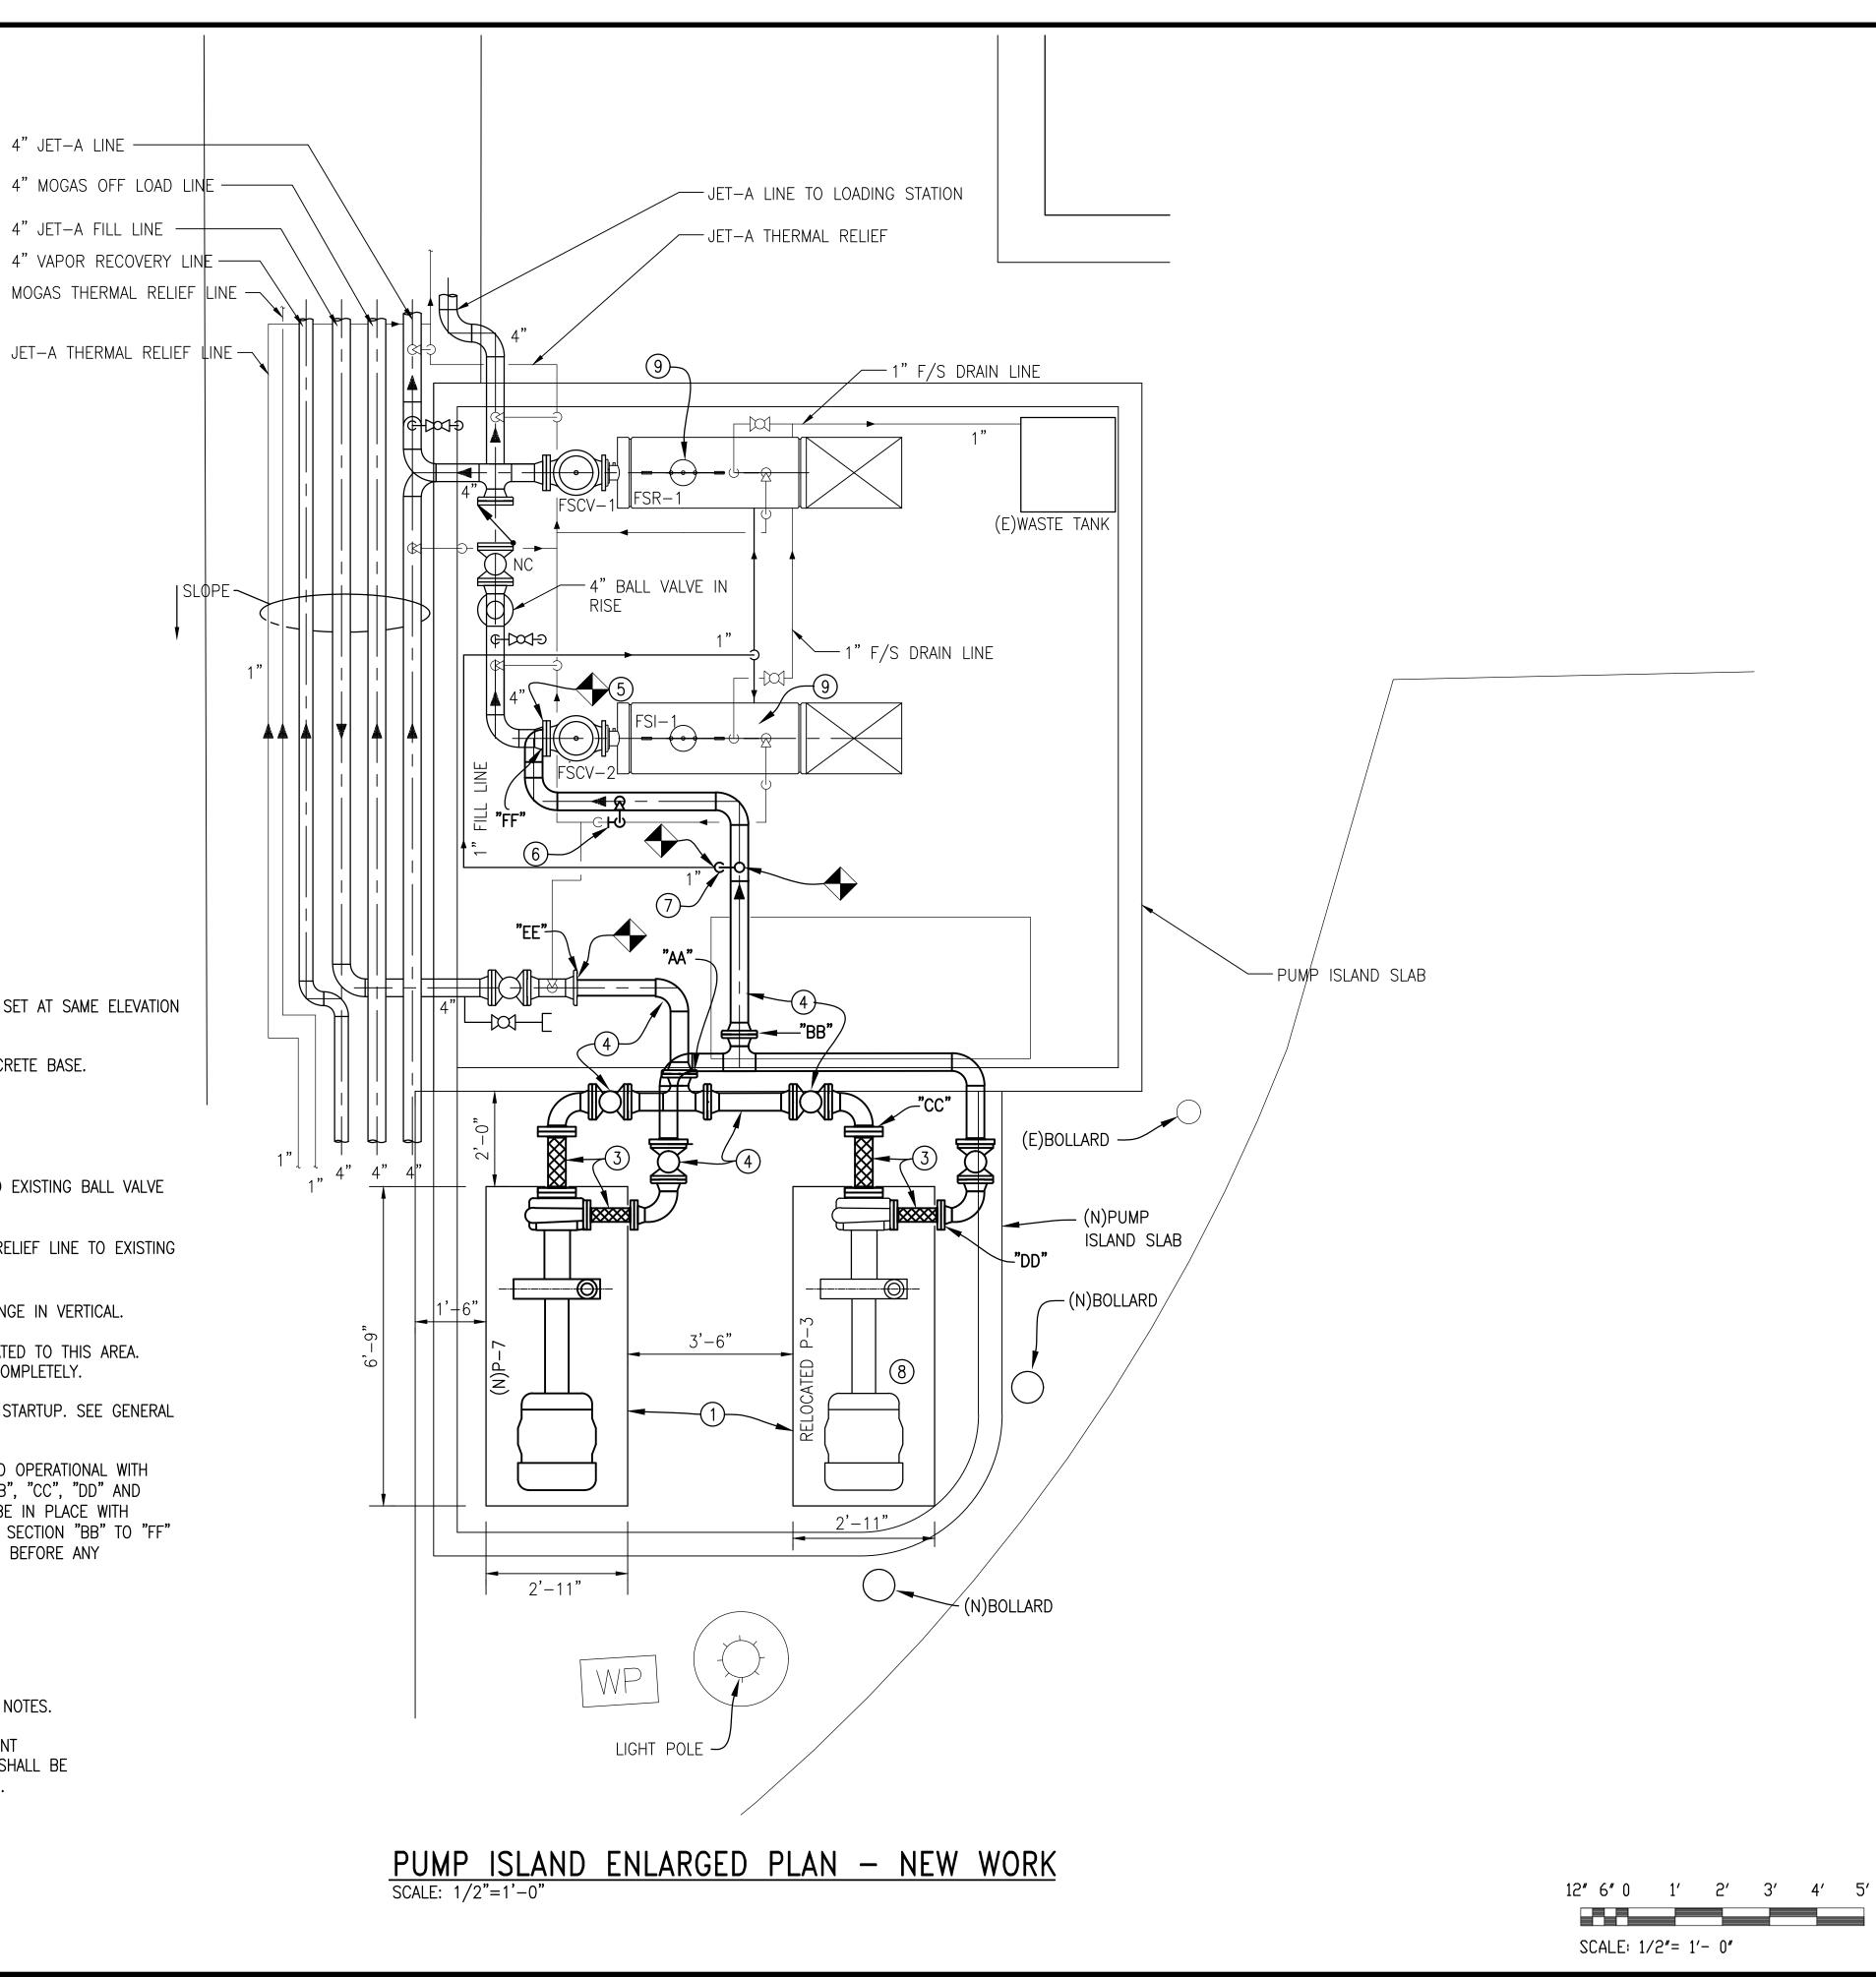


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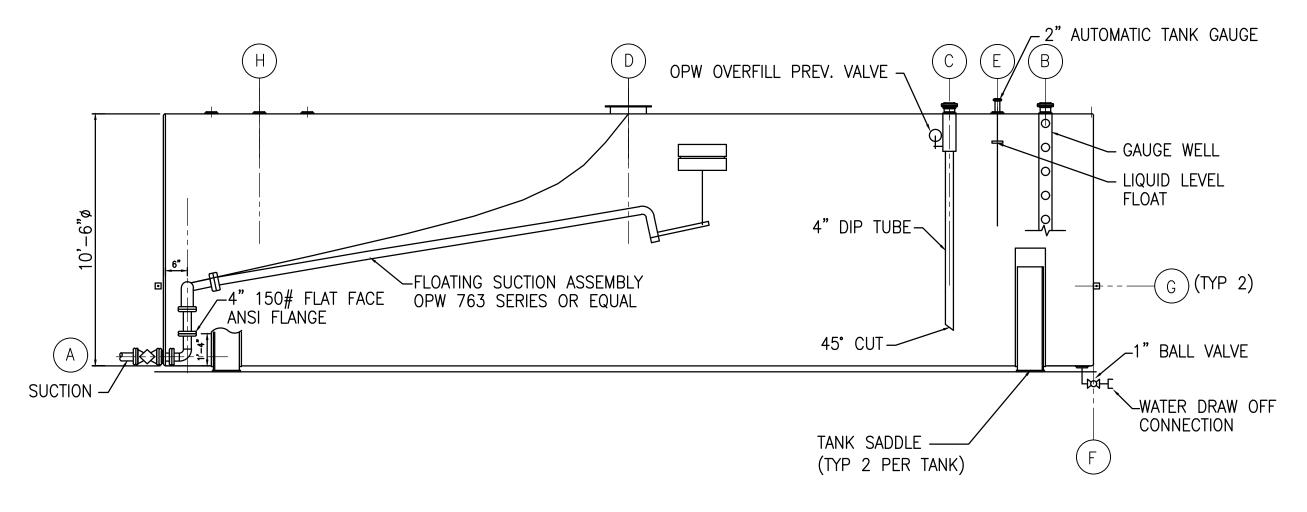


AVCON PROJECT NO.

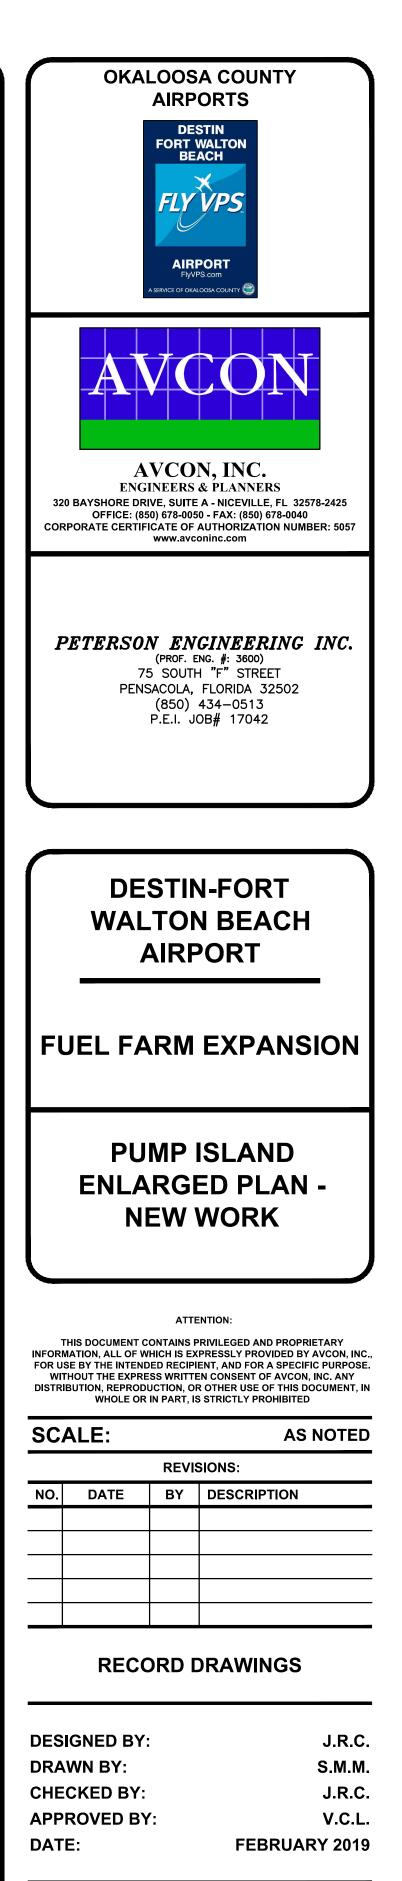
2017.050.02



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SCALE: 1/4"=1'-0"

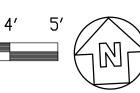

# JET A TANK SECTION 25,000 GAL. (TYPE 2)

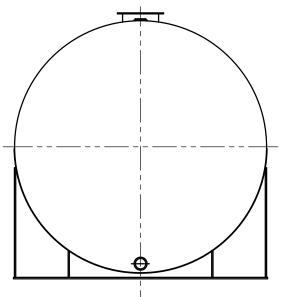
5′ 5′ 0 SCALE: 1/4"= 1'-0"

# NOTES:

- 1. SEE P-105 FOR GENERAL NOTES, LEGEND, ABBREVIATIONS AND SCOPE OF WORK.
- 2. MANWAYS SHALL BE PROVIDED WITH LONG BOLTS TO PROVIDE EMERGENCY RELIEF VENTING.
- 3. CONTRACTOR SHALL ENSURE THAT MANWAY LADDER SHALL NOT IMPEDE OPERATION OF FLOATING SUCTION AND THAT FLOATING SUCTION DOES NOT IMPEDE ENTRY/USE OF MANWAY LADDER. LADDERS NOT SHOWN FOR CLARITY.
- 4. THE CONTRACTOR SHALL INSTALL NEW LEAK DETECTION SENSORS IN BOTH NEW JET A TANKS, WHICH ARE COMPATIBLE WITH THE EXISTING VEEDER ROOT PANEL, AND MAKE ALL CONNECTIONS.

JET-A TANK NOZZLE SCHEDULE	-	
A 4" PUMP SUCTION – RF FLANGE		
B 2" ATMOSPHERIC VENT WITH GAUG	Ε ΗΑΤ	
C 4" FILL CONN – RF FLANGE		
D 24" MANWAY W/ BLIND FLANGE COV	/ER	
E 2" ATG (AUTOMATIC TANK GAUGE)	– RF	
F 1" WATER DRAIN-OFF CONN 30	000#	
G – GROUNDING LUG – 3"x3"x¼" P – WELD TO TANK	LATE	
H 4" EMERGENCY VENT		
NOTE: 6" NOZZLE PROJECTION (TYPICAL)		

ATCH FOR DIP STICK
RF FLANGE
THD CPLG.
EW∕½"øHOLE

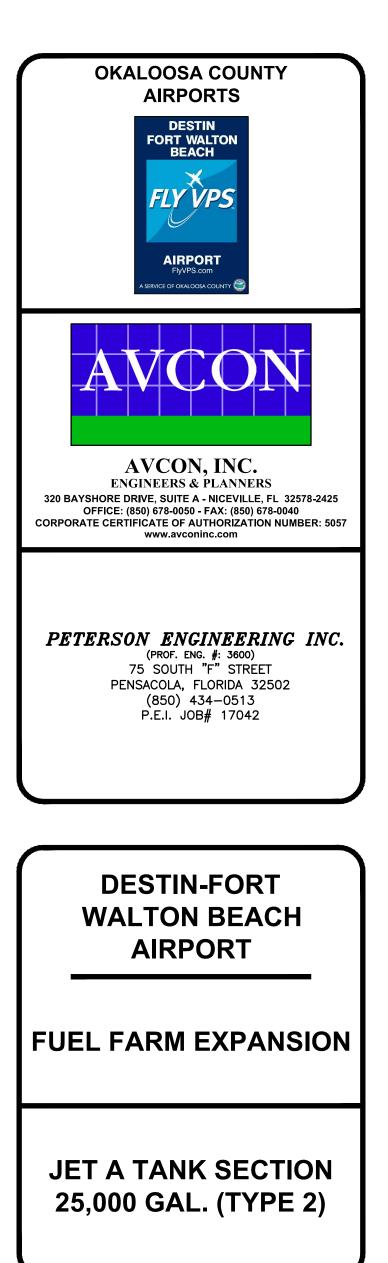

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REVISIONS:			
NO.	DATE	BY	DESCRIPTION

### **RECORD DRAWINGS**

DESIGNED BY:	J.R.C.
DRAWN BY:	S.M.M.
CHECKED BY:	J.R.C.
APPROVED BY:	V.C.L.
DATE:	FEBRUARY 2019

AVCON PROJECT NO.

2017.050.02

# IFGFND

### ABBREVIATIONS

LEGEND			
	BALL VALVE PLUG VALVE, DOUBLE BLOCK AND BLEED ABOVEGROUND PIPE BLIND FLANGE	F/S FSCV E N RF	FILTER SEPARATOR FILTER SEPARATOR CONTROL VALVE EXISTING NEW RAISED FACE
 ⊂ ⊠  	CAP QUICK CONNECTOR FLEXIBLE CONNECTION MANUAL AIR VENT 90 DEG ELBOW DOWN	"A"	LETTER INDICATES SEQUENCE OF WORK TO BE DONE. SEE NEW WORK NOTES.

## GENERAL NOTES

- 1. BEFORE SUBMITTING PROPOSALS, EACH BIDDER SHALL VISIT THE SITE, EXAMINE ALL DRAWINGS AND SPECIFICATIONS, FULLY FAMILIARIZE HIMSELF WITH ALL JOB CONDITIONS AND SHALL BE FULLY INFORMED AS TO THE EXTENT OF VERY LIMITED DOWN TIME AND OF HIS WORK. ALL OUTAGES SHALL BE WITHIN A 6 HOUR WINDOW AT NIGHT. ACTUAL HOURS OF OUTAGE SHALL BE COORDINATED WITH THE AIRPORT PRIOR TO INITIATING OUTAGE. NO CONSIDERATION SHALL BE GIVEN TO MISUNDERSTANDING OF THE REQUIREMENTS OF WORK INVOLVED.
- 2. THE CONTRACTOR SHALL VERIFY THE EXACT DIMENSIONS IN THE FIELD. FLANGES OF VALVES, PIPING AND EQUIPMENT (NEW AND EXISTING) SHALL MATCH BEFORE ANY EXISTING SERVICES ARE DISCONNECTED. ALL EXISTING PIPING AND EQUIPMENT TO BE REMOVED SHALL REMAIN ON SITE UNDAMAGED UNTIL NEW IS INSTALLED AND ONLINE.
- 3. IF FOR ANY REASON IT LOOKS LIKE THE NEW SYSTEM CANNOT BE PUT IN SERVICE IN THE ALLOTTED TIME, THE EXISTING SYSTEM SHALL REMAIN IN SERVICE.
- 4. THESE DRAWINGS ARE DIAGRAMMATIC IN NATURE. NOT ALL COMPONENTS ARE SHOWN IN ALL VIEWS. THE CONTRACTOR SHALL MAKE USE OF THE ENTIRE SET OF DRAWINGS AND SPECIFICATIONS AND INCLUDE ALL COMPONENTS TO CONSTRUCT A FULLY OPERATIONAL FUELING SYSTEM.
- 5. THE CONTRACTOR SHALL DEVELOP TO SCALE PIPE FABRICATION SHOP DRAWINGS FOR APPROVAL PRIOR TO ANY INSTALLATION.
- 6. WRITTEN DIMENSIONS ON DRAWINGS SHALL HAVE PRECEDENCE OVER SCALED DIMENSIONS. CONTRACT SHALL FIELD VERIFY DIMENSIONS PRIOR TO FABRICATION
- 7. THE CONTRACTOR SHALL COORDINATE ALL HIS WORK WITH ALL OTHER TRADES BEFORE ANY INSTALLATION IS MADE.
- 8. AT START OF CONSTRUCTION, THE CONTRACTOR AND EACH OF HIS SUBCONTRACTORS SHALL PREPARE TYPED LISTS OF ALL EQUIPMENT THAT THEY ARE SUPPLYING WHICH REQUIRE ELECTRICAL WORK, AND SEND LISTS TO THE ELECTRICAL CONTRACTOR FOR HIS REVIEW AND COORDINATION.
- 9. ALL EQUIPMENT SHALL BE INSTALLED IN ACCORDANCE WITH MANUFACTURER'S APPROVED PUBLISHED LITERATURE.
- 10. INSTALLATION OF EQUIPMENT SHALL PERMIT ACCESSIBILITY FOR SERVICE AND/OR REPLACEMENT.
- 11. AFTER COMPLETION OF WORK, THE FUEL SYSTEM SHALL BE CYCLED TO CAPTURE ANY DEBRIS IN THE PIPING SYSTEM BEFORE REMOVAL OF THE EXISTING FILTER MEDIA AND REPLACE FILTER MEDIA WITH NEW.
- 12. THE CONTRACTOR SHALL COORDINATE AND OBTAIN HOT WORK PERMITS WITH EGLIN AFB AND OKALOOSA COUNTY FIRE INSPECTOR BEFORE BEGINNING ANY WELDING ON SITE.

# SCOPE:


THE MECHANICAL SCOPE INCLUDES BUT IS NOT LIMITED TO: INSTALLATION OF (2) NEW 25,000 GALLON JET-A TANKS AND PUMPS.

PUMP SCHEDULE						
DESIGNATION	SERVES	TYPE	SERVICE	FLOW GPM	FT. HEAD	Motor HP
P-7	LOADING	SELF PRIMING CENTRIFUGAL	JET–A	300	192	40

 $\sqrt{1}$ 

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AVCON PROJECT NO.

2017.050.02
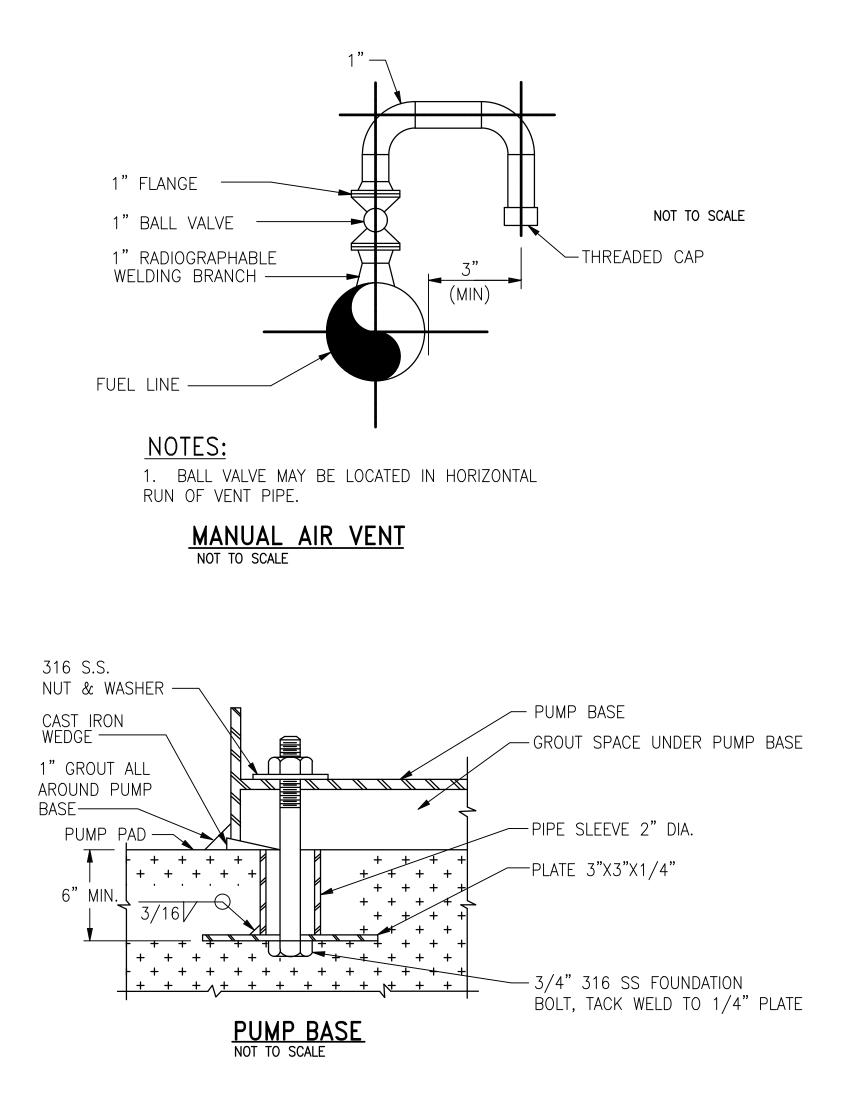
# ELECTRICAL GENERAL NOTES

- 1. ENTIRE ELECTRICAL INSTALLATION SHALL BE IN ACCORDANCE WITH THE LATEST ACCEPTED EDITION OF THE NATIONAL ELECTRICAL INSTALLATION SHALL BE IN ACCORDANCE WITH THE LATEST ACCEPTED EDITION OF THE NATIONAL ELECTRICAL INSTALLATION SHALL BE IN ACCORDANCE WITH THE LATEST ACCEPTED EDITION OF THE NATIONAL ELECTRICAL INSTALLATION SHALL BE IN ACCORDANCE WITH THE LATEST ACCEPTED EDITION OF THE NATIONAL ELECTRICAL INSTALLATION SHALL BE IN ACCORDANCE WITH THE LATEST ACCEPTED EDITION OF THE NATIONAL ELECTRICAL INSTALLATION SHALL BE IN ACCORDANCE WITH THE LATEST ACCEPTED EDITION OF THE NATIONAL ELECTRICAL INSTALLATION SHALL BE IN ACCORDANCE WITH THE LATEST ACCEPTED EDITION OF THE NATIONAL ELECTRICAL INSTALLATION IN ACCORDANCE WITH THE LATEST ACCEPTED EDITION OF THE NATIONAL ELECTRICAL INSTALLATION IN ACCORDANCE WITH THE LATEST ACCEPTED EDITION OF THE NATIONAL ELECTRICAL INSTALLATION IN ACCORDANCE WITH THE LATEST ACCEPTED EDITION OF THE NATIONAL ELECTRICAL INSTALLATION IN ACCORDANCE WITH THE LATEST ACCEPTED EDITION OF THE NATIONAL ELECTRICAL INSTALLATION IN ACCORDANCE WITH THE LATEST ACCEPTED EDITION OF THE NATIONAL ELECTRICAL INSTALLATION IN ACCORDANCE WITH THE LATEST ACCEPTED EDITION OF THE NATIONAL ELECTRICAL INSTALLATION IN ACCORDANCE WITH THE LATEST ACCEPTED EDITION OF THE NATIONAL ELECTRICAL INSTALLATION IN ACCORDANCE WITH THE LATEST ACCEPTED EDITION OF THE NATIONAL ELECTRICAL INSTALLATION IN ACCORDANCE WITH THE LATEST ACCEPTED EDITION OF THE NATIONAL ELECTRICAL INSTALLATION IN ACCORDANCE WITH THE LATEST ACCEPTED EDITION OF THE NATIONAL ELECTRICAL INSTALLATION IN ACCORDANCE WITH THE LATEST ACCEPTED EDITION IN ACCORDANCE WITH THE NATIONAL ELECTRICAL INSTALLATION IN ACCORDANCE WITH THE LATEST ACCEPTED EDITION IN ACCORDANCE WITH THE PRATICAL IN ACCORDANCE WITH THE PRATICAL INTERNATION IN ACCORDANCE WITH THE PRATICAL INTERNATIONAL IN ACCORDANCE WITH THE PRATICAL INTERNATIONAL INTERNATIONA AND ALL LOCAL CODES.
- 2. ALL ELECTRICAL WORK AND MATERIALS USED IN THIS PROJECT SHALL BE NEW, UNDERWRITERS' LABORITORIES (UL) LISTED AND LABELED, AND SHALL BE FURNISHED AND INSTALLED BY THE CONTRACTOR UNLESS NOTED OTHERWISE.
- 3. CONDUIT ROUTINGS AND DEVICE/EQUIPMENT LOCATIONS SHOWN ARE DIAGRAMMATIC ONLY, CONTRACTOR SHALL FIELD ROUTE AND LOCATE AS REQUIRED.
- 4. ALL NEW CONDUITS RUN UNDERGROUND SHALL HAVE A MINIMUM BURIAL DEPTH OF 36" UNLESS NOTED OTHERWISE.
- 5. FURNISH 1/4" NYLON PULL ROPE IN ALL EMPTY CONDUITS FOR PULLING OF CONDUCTORS/CABLES.
- 6. WHERE CONFLICTS OCCUR ON ELECTRICAL DRAWINGS BETWEEN DRAWINGS, SPECIFICATIONS AND CODES, THE MOST STRINGENT REQUIREMENT THAT APPLIES SHALL BE ADHERED TO.
- 7. ELECTRICAL CONTRACTOR SHALL FIELD VERIFY ALL EXISTING CONDITIONS PRIOR TO BEGINNING ANY WORK AND SHALL IMMEDIATELY NOTIFY THE GOVERNMENT INSPECTOR OF ANY DISCREPANCIES. FAILURE TO DO SO INDICATES THAT THE CONTRACTOR ACCEPTS THE CONDITIONS AS THEY EXIST AND SHALL PERFORM THE WORK AS SHOWN AND SPECIFIED.
- 8. CONTRACTOR SHALL COORDINATE ALL WORK WITH OTHER TRADES PRIOR TO INSTALLATION.
- 9. ALL NEW EQUIPMENT, JUNCTION BOXES, ETC SHALL BE FURNISHED WITH LAMINATED PLASTIC NAMEPLATES. NAMEPLATES SHALL BE MELAMINE PLASTIC, 0.125" THICK, WHITE WITH BLACK CENTER CORE. SURFACE SHALL BE MATTE FINISHED. CORNERS SHALL BE SQUARE. ACCURATELY ALIGN LETTERING AND ENGRAVE INTO THE CORE. MINIMUM SIZE OF NAMEPLATES SHALL BE 1" X 2 1/2". LETTERING SHALL BE A MINIMUM OF .25" HIGH, NORMAL BLOCK STYLE. FASTEN NAMEPLATES WITH A MINIMUM OF TWO SHEET-METAL SCREWS OR TWO RIVETS, PER NAMEPLATE. COORDINATE NAMEPLATE VERBIAGE WITH VPS PERSONNEL.
- 10. WORKING SPACE OF 36" FOR 208/120 VOLT SYSTEMS SHALL BE MAINTAINED IN FRONT OF ALL ELECTRICAL PANELS AND DEVICES.
- 11. NEW SAFETY SWITCH DISCONNECTS SHALL BE MOUNTED AT 48" A.F.F. TO CENTER AND SHALL HAVE 3'-0" MIN. OF WORKING SPACE IN FRONT OF DISCONNECT.
- 12. USE OF SERIES RATED CIRCUIT BREAKERS IS NOT ALLOWED.
- 13. USE OF PLUG-IN CIRCUIT BREAKERS IS NOT ALLOWED.
- 14. OBTAIN ALL PERMITS REQUIRED BY THE LOCAL JURISDICTION.
- 15. PROVIDE OPERATORS & ENCLOSURES SUITABLE FOR CONTROL STATION LOCATION: EXPLOSION-PROOF (NEMA 7) FOR HAZARDOUS CLASSIFIED LOCATIONS; WEATHERPROOF (NEMA 4) FOR OUTDOOR NON-HAZARDOUS LOCATIONS; AND GENERAL PURPOSE (NEMA 12) FOR INDOOR NON-HAZARDOUS LOCATIONS.
- 16. LOCATE ALL UTILITIES PRIOR TO DIGGING.
- 17. INSTALL ALL CONDUIT, DEVICES, EQUIPMENT, ETC PER NFPA 70 (NATIONAL ELECTRIC CODE) ARTICLES 501, 502 AND 514. A LISTED SEALED FITTING SHALL BE THE FIRST FITTING AFTER THE CONDUIT EMERGES FROM THE EARTH OR CONCRETE. IF A CONDUIT ENTERS A HAZARDOUS LOCATION A SEAL MUST BE PROVIDED ON BOTH CONDUIT ENDS REGARDLESS IF ONE OR BOTH ENDS ARE IN A NON-HAZARDOUS SPACE.

# ELECTRICAL LEGEND

ECTRICAL	CODE,	FLORIDA	BUILDING	CODE,	

— G4 ·	
— NG	
N 🕥	

EXISTING 3/4" X 10"–0" COPPERCLAD GROUND ROD, 18" BELOW FINISHED GRADE.
EXISTING $\#1/0$ bare copper ground conductor, uio
EXISTING #4/0 BARE COPPER GROUND CONDUCTOR
NEW #4/0 BARE COPPER GROUND CONDUCTOR
NEW 3/4" X 10"—0" COPPERCLAD GROUND ROD, 18" BELOW FINISHED GRADE.



# NOTES AND LEGEND

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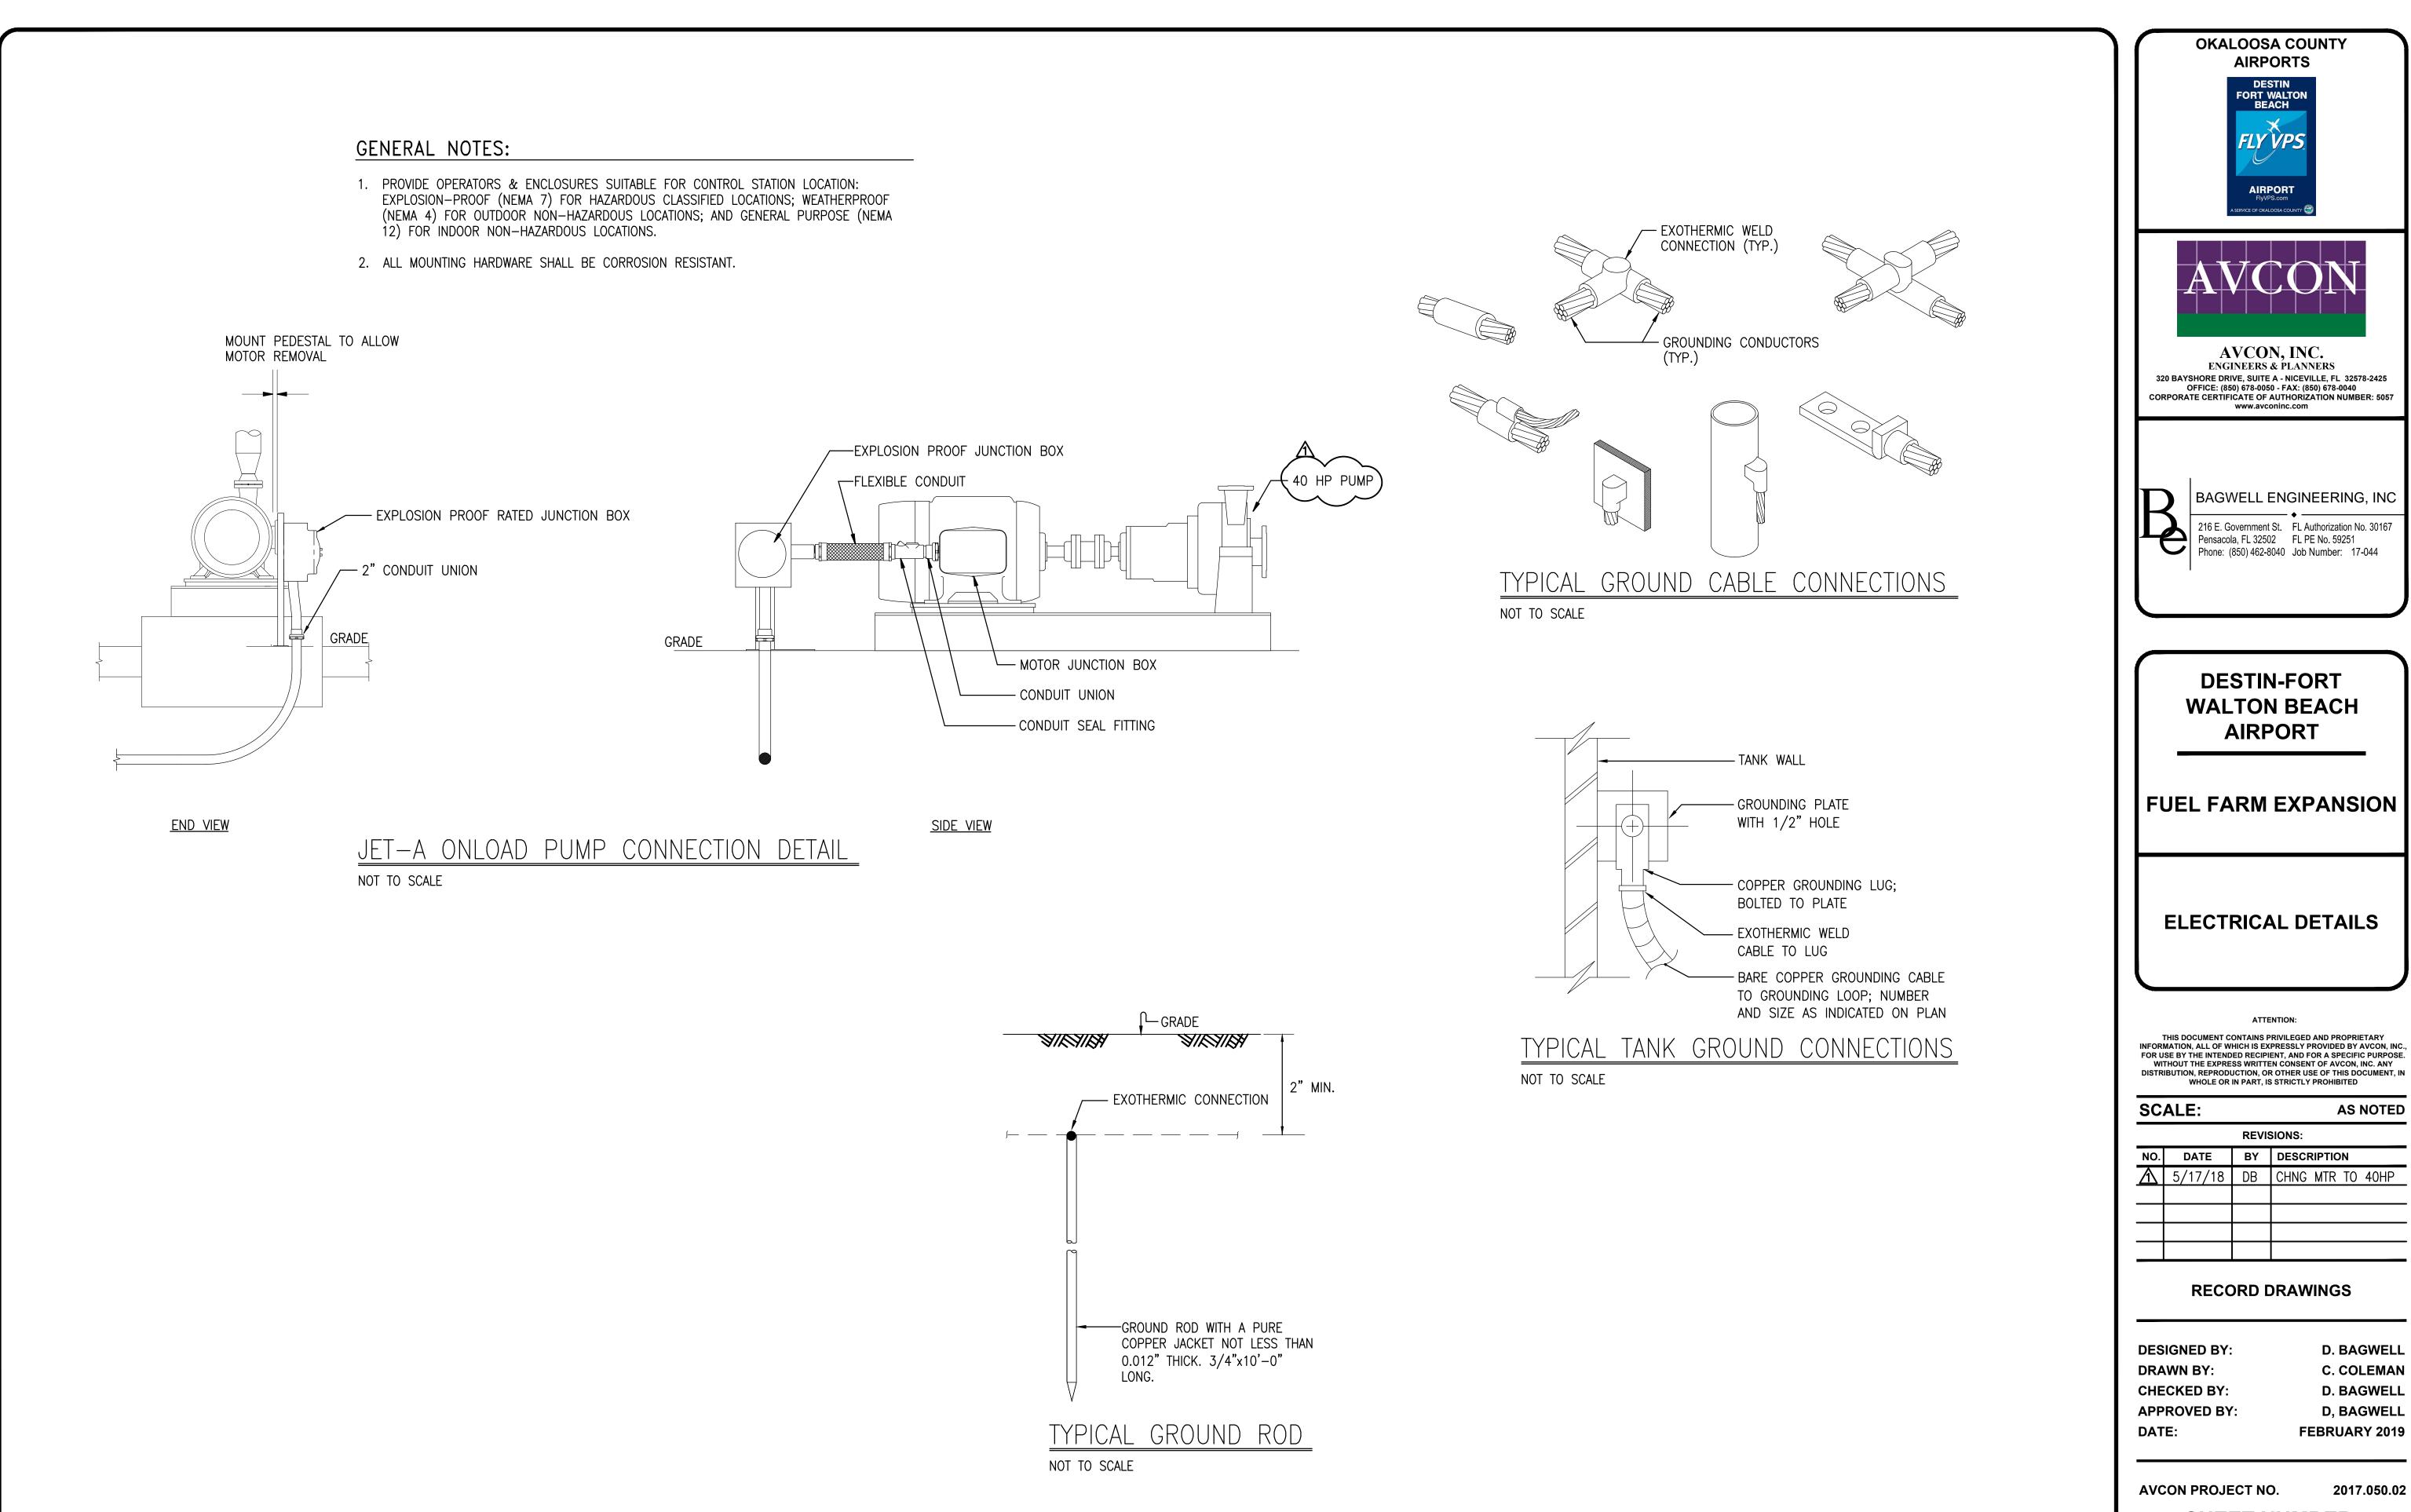
DESIGNED BY:	D. BAGWELL
DRAWN BY:	C. COLEMAN
CHECKED BY:	D. BAGWELL
APPROVED BY:	D, BAGWELL
DATE:	FEBRUARY 2019

AVCON PROJECT NO.

2017.050.02

E-001


SHEET NUMBER




DESIGNED BY:	D. E
DRAWN BY:	C. (
CHECKED BY:	D. E
APPROVED BY:	D, E
DATE:	FEBRU

SHEET NUMBER

**E-002** 

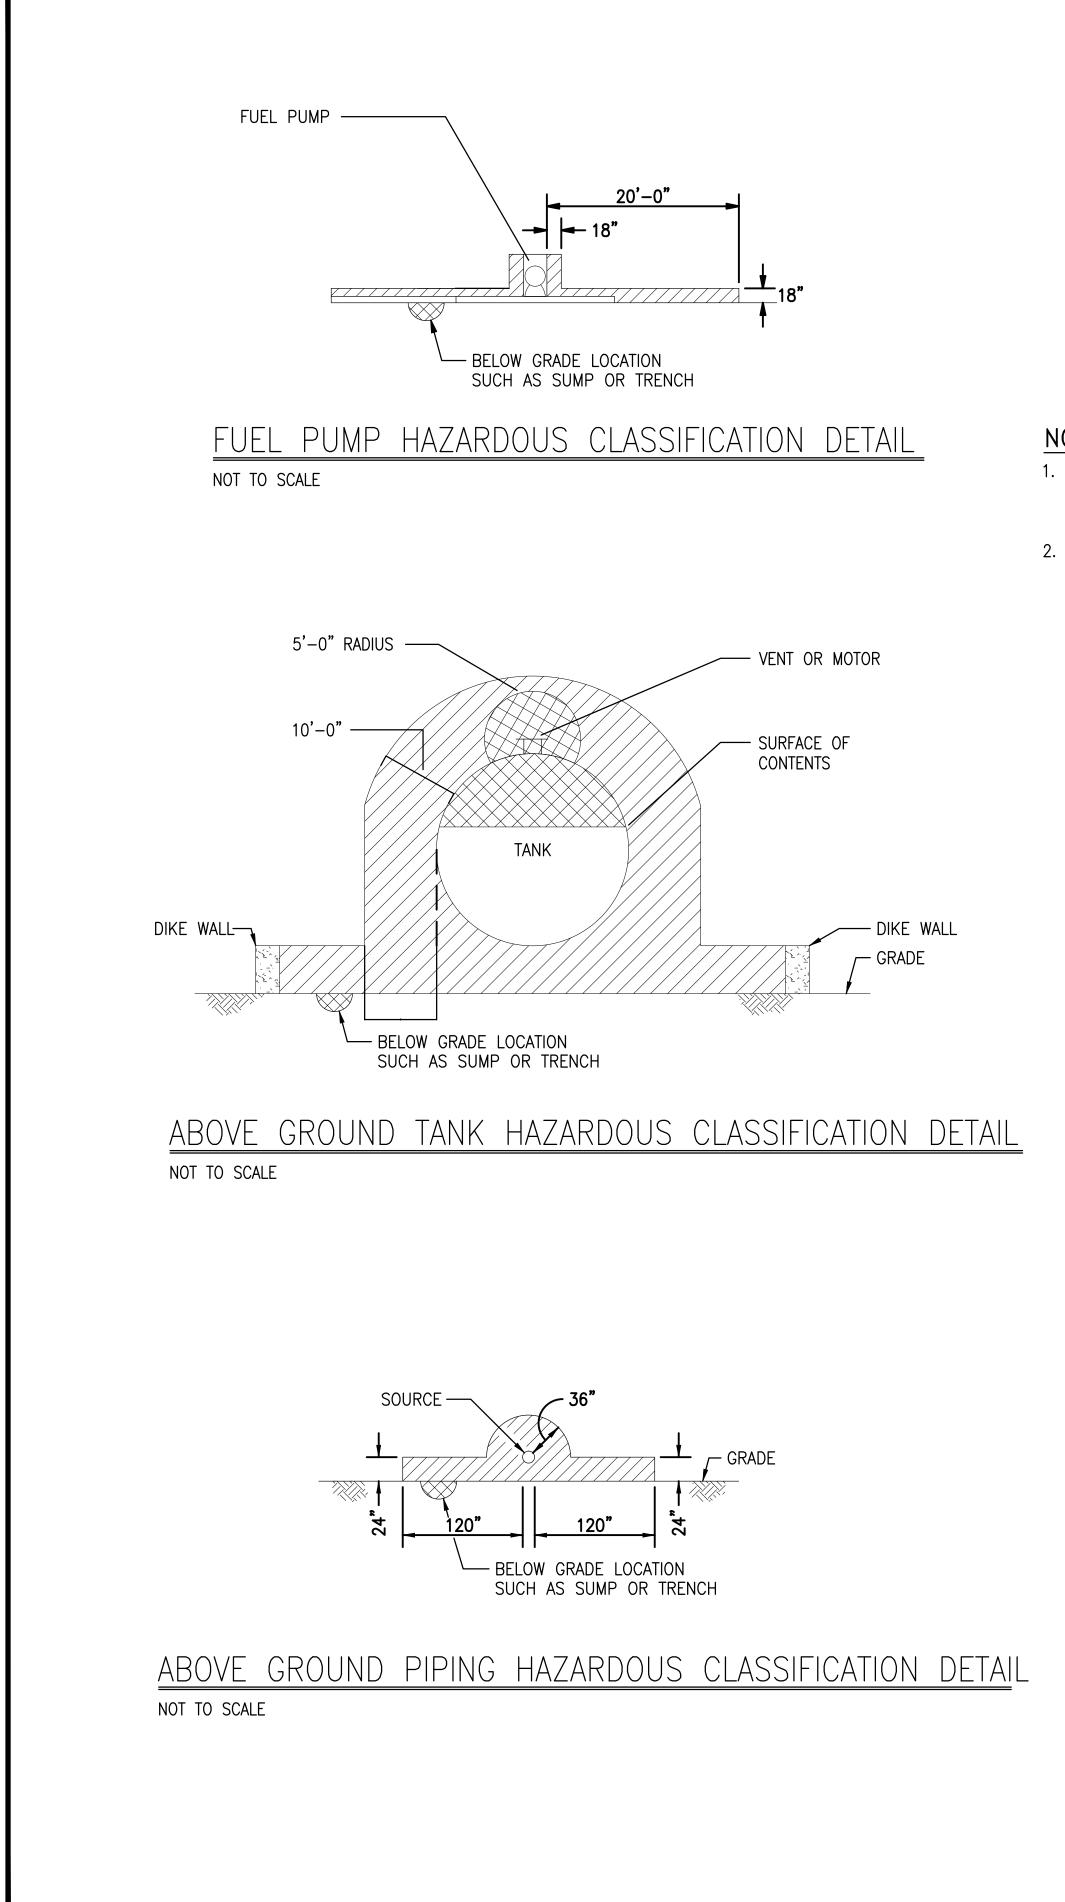

### CLASSIFICATION LEGEND:

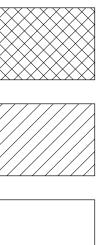

CLASS I, DIVISION 1, GROUP D HAZARDOUS AREA (T2D, 251°C (419°F) MAX.)

CLASS I, DIVISION 2, GROUP D HAZARDOUS AREA (T2D, 251°C (419°F) MAX.)

NONCLASSIFIED AREA

### NOTES:

1. ALL ELECTRICAL WORK IN HAZARDOUS AREAS SHALL BE IN ACCORDANCE WITH NATIONAL ELECTRICAL CODE ARTICLE 501 FOR CLASSIFICATION INDICATED.

2. DETAIL APPLIES TO ABOVEGROUND PIPING WITH VALVES, SCREWED FITTINGS, FLANGES OR SIMILAR ACCESSORIES. REFER TO CIVIL AND MECHANICAL PLANS FOR PIPING.

			MOUNTING:	SURF	ACE, NEMA 3R		1	1
DEVICE		BRANCH CIRCUIT						BRANCH CIRC
AMP TRIP	POLES	DESIGNATION	CONN. VA	NO.		NO.	CONN. VA	DESIGNATION
ł	<b>A</b>			1		2		FUEL FARM L
				3		4		
90	3	JET-A OFFLOAD PUMP		5		6		FUEL FARM L
				7		8		VEEDER ROOT
				9		10		GATE CONTRO
				11		12		DIESEL PUMP
60	2	SPARE		13		14		
				15		16		FUEL OPERAT
20	1	EMERGENCY STOP		17		18		
15	1	GENERATOR LTS/RECEP		19		20		FILL VALVE A
1				21		22		RECEPTACLE
60	3	MOGAS OFFLOAD PUMP		23		24		CCTV RECEPT
				25		26		CANOPY LIGH
20	2	GATE OPERATOR FED FROM LTF		27		28		SPACE
				29		30		SPACE
20	2	GATE OPERATOR FED FROM LTF		31		32		SPACE
		+		33		34		SPACE
·	1	SPACE		35		36		SPACE
	1	SPACE		37		38		SPACE
	1	SPACE		39		40		UNUSABLE SI
	1	UNUSABLE SPACE		41		42		UNUSABLE SF
						BOTTON	1	JET-A ONLOA
PANEL:		LTF						



<b>DESTIN-FORT</b>		
WALTON BEACH		
AIRPORT		

# FUEL FARM EXPANSION

# HAZARDOUS LOCTION DETAILS AND PANEL SCHEDULE

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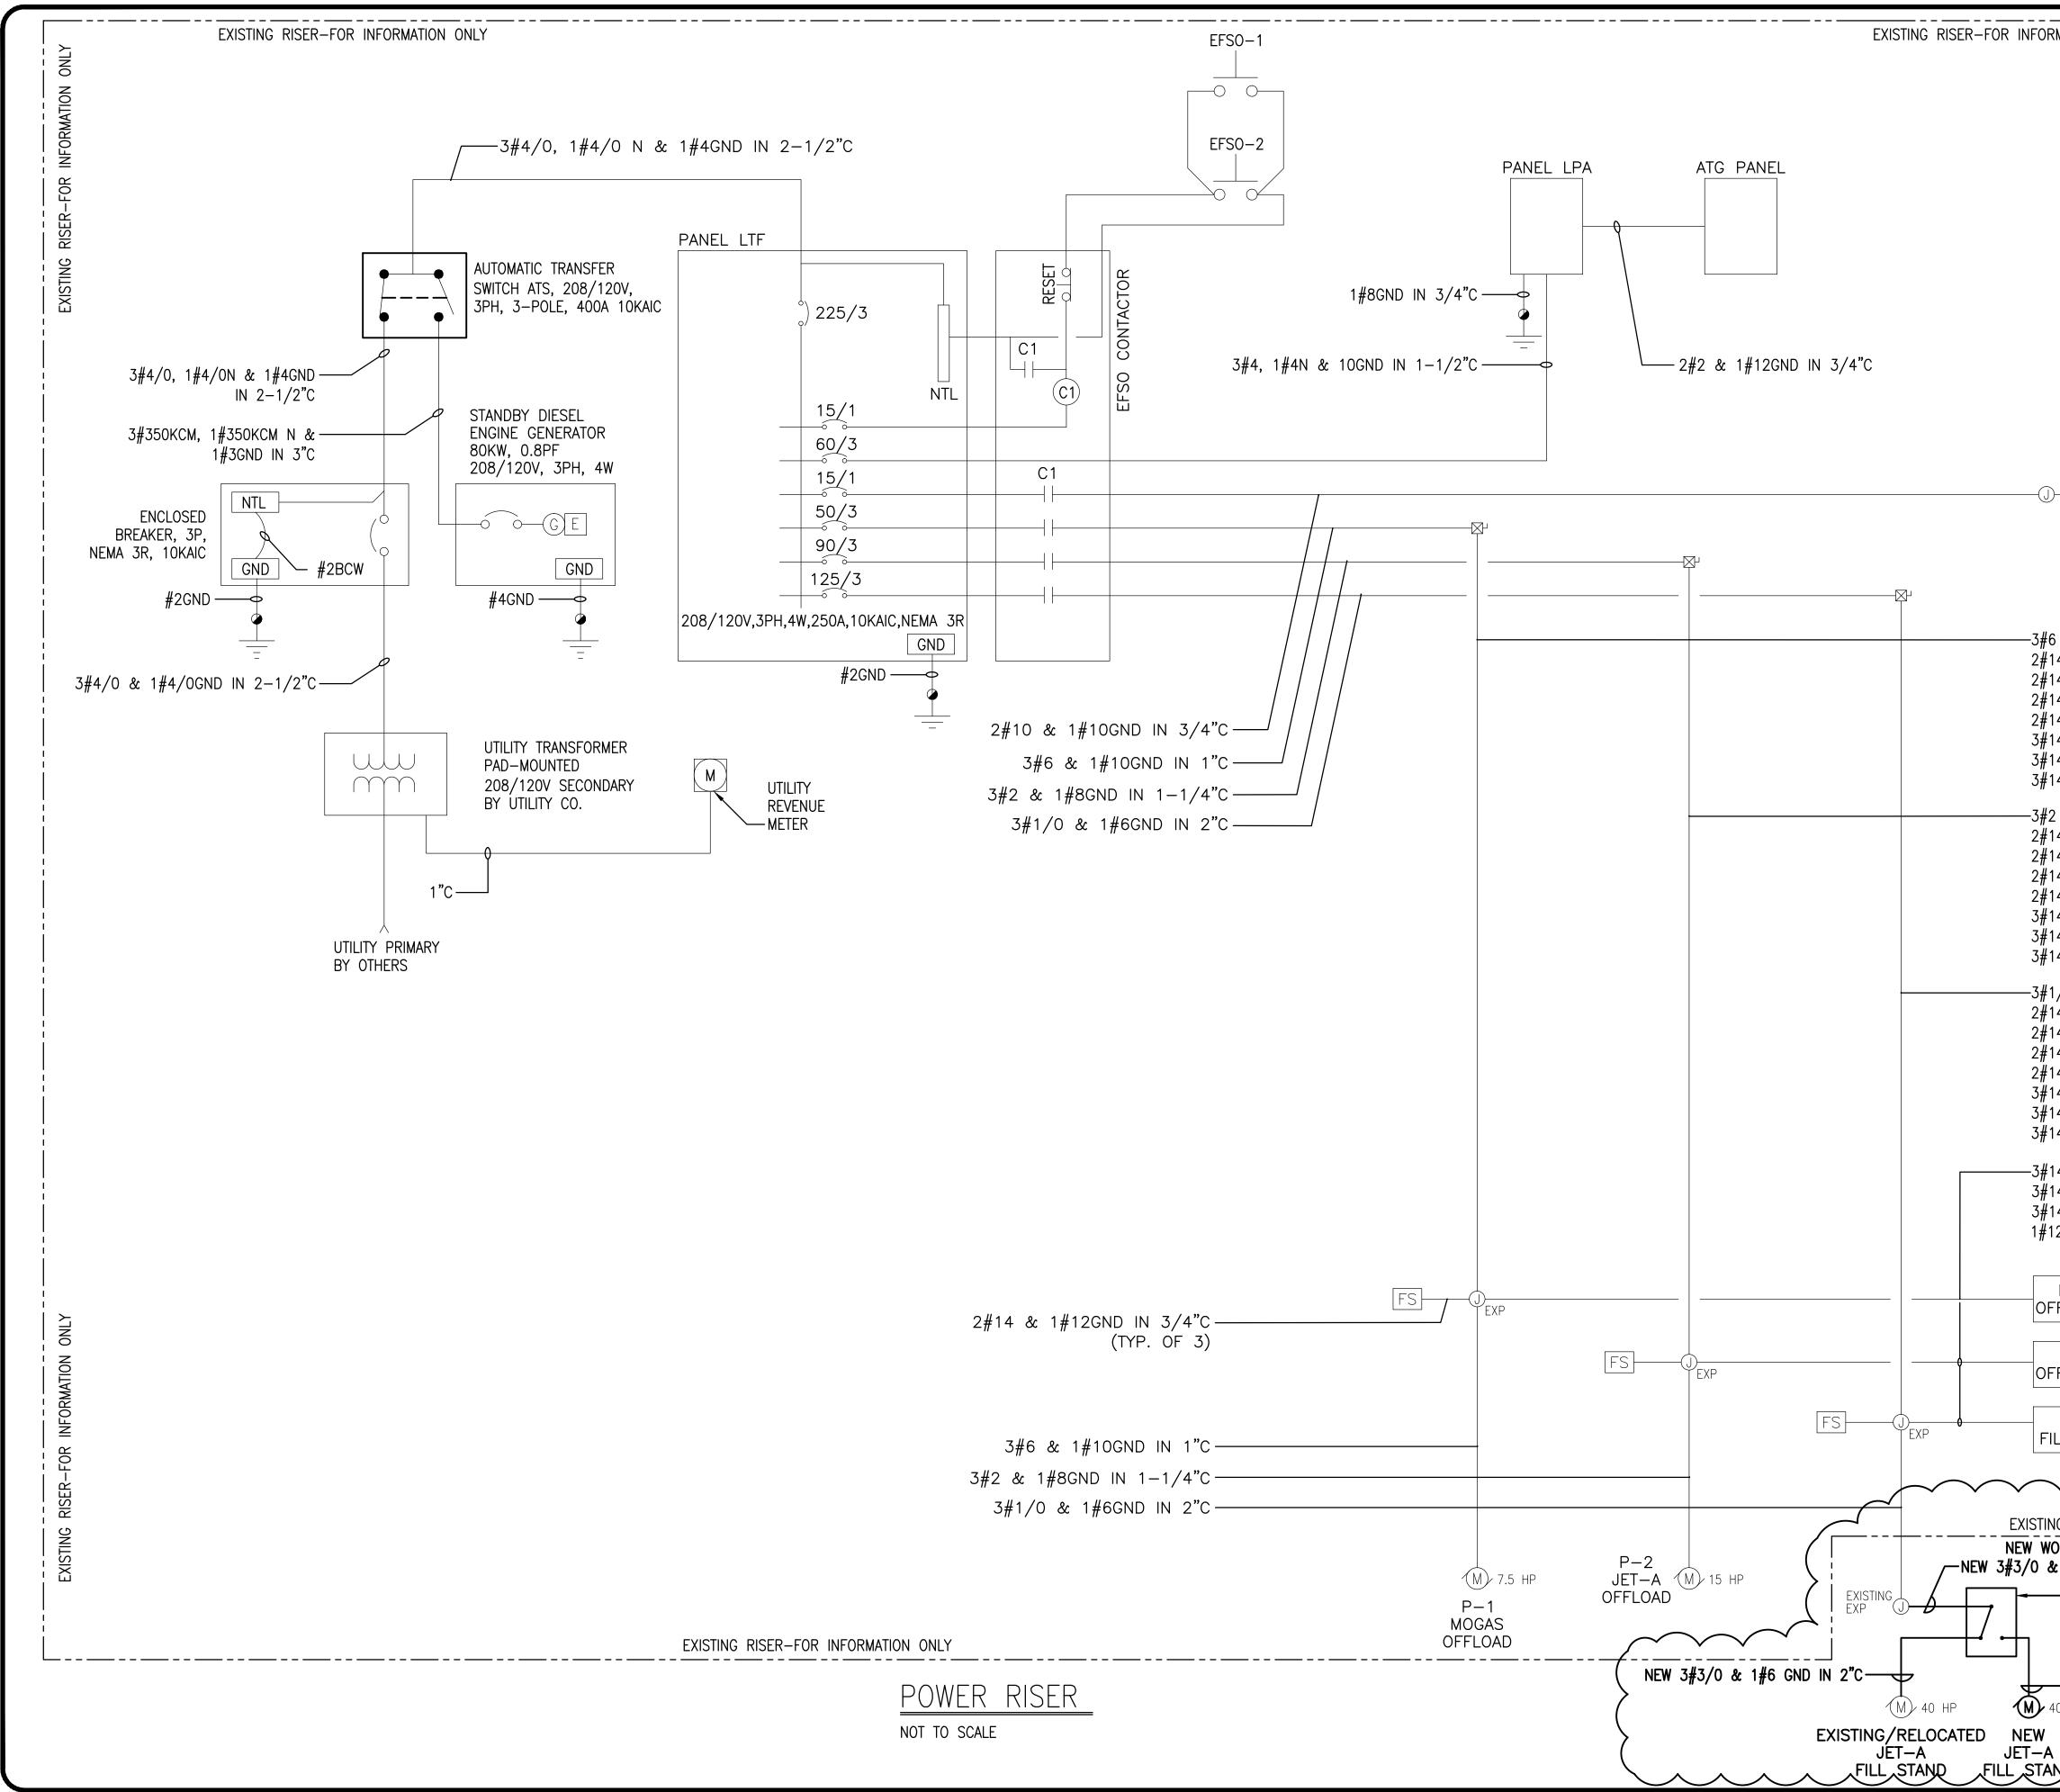
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DRAWN BY:	C. COLEMAN
CHECKED BY:	D. BAGWELL
APPROVED BY:	D, BAGWELL
DATE:	FEBRUARY 2019

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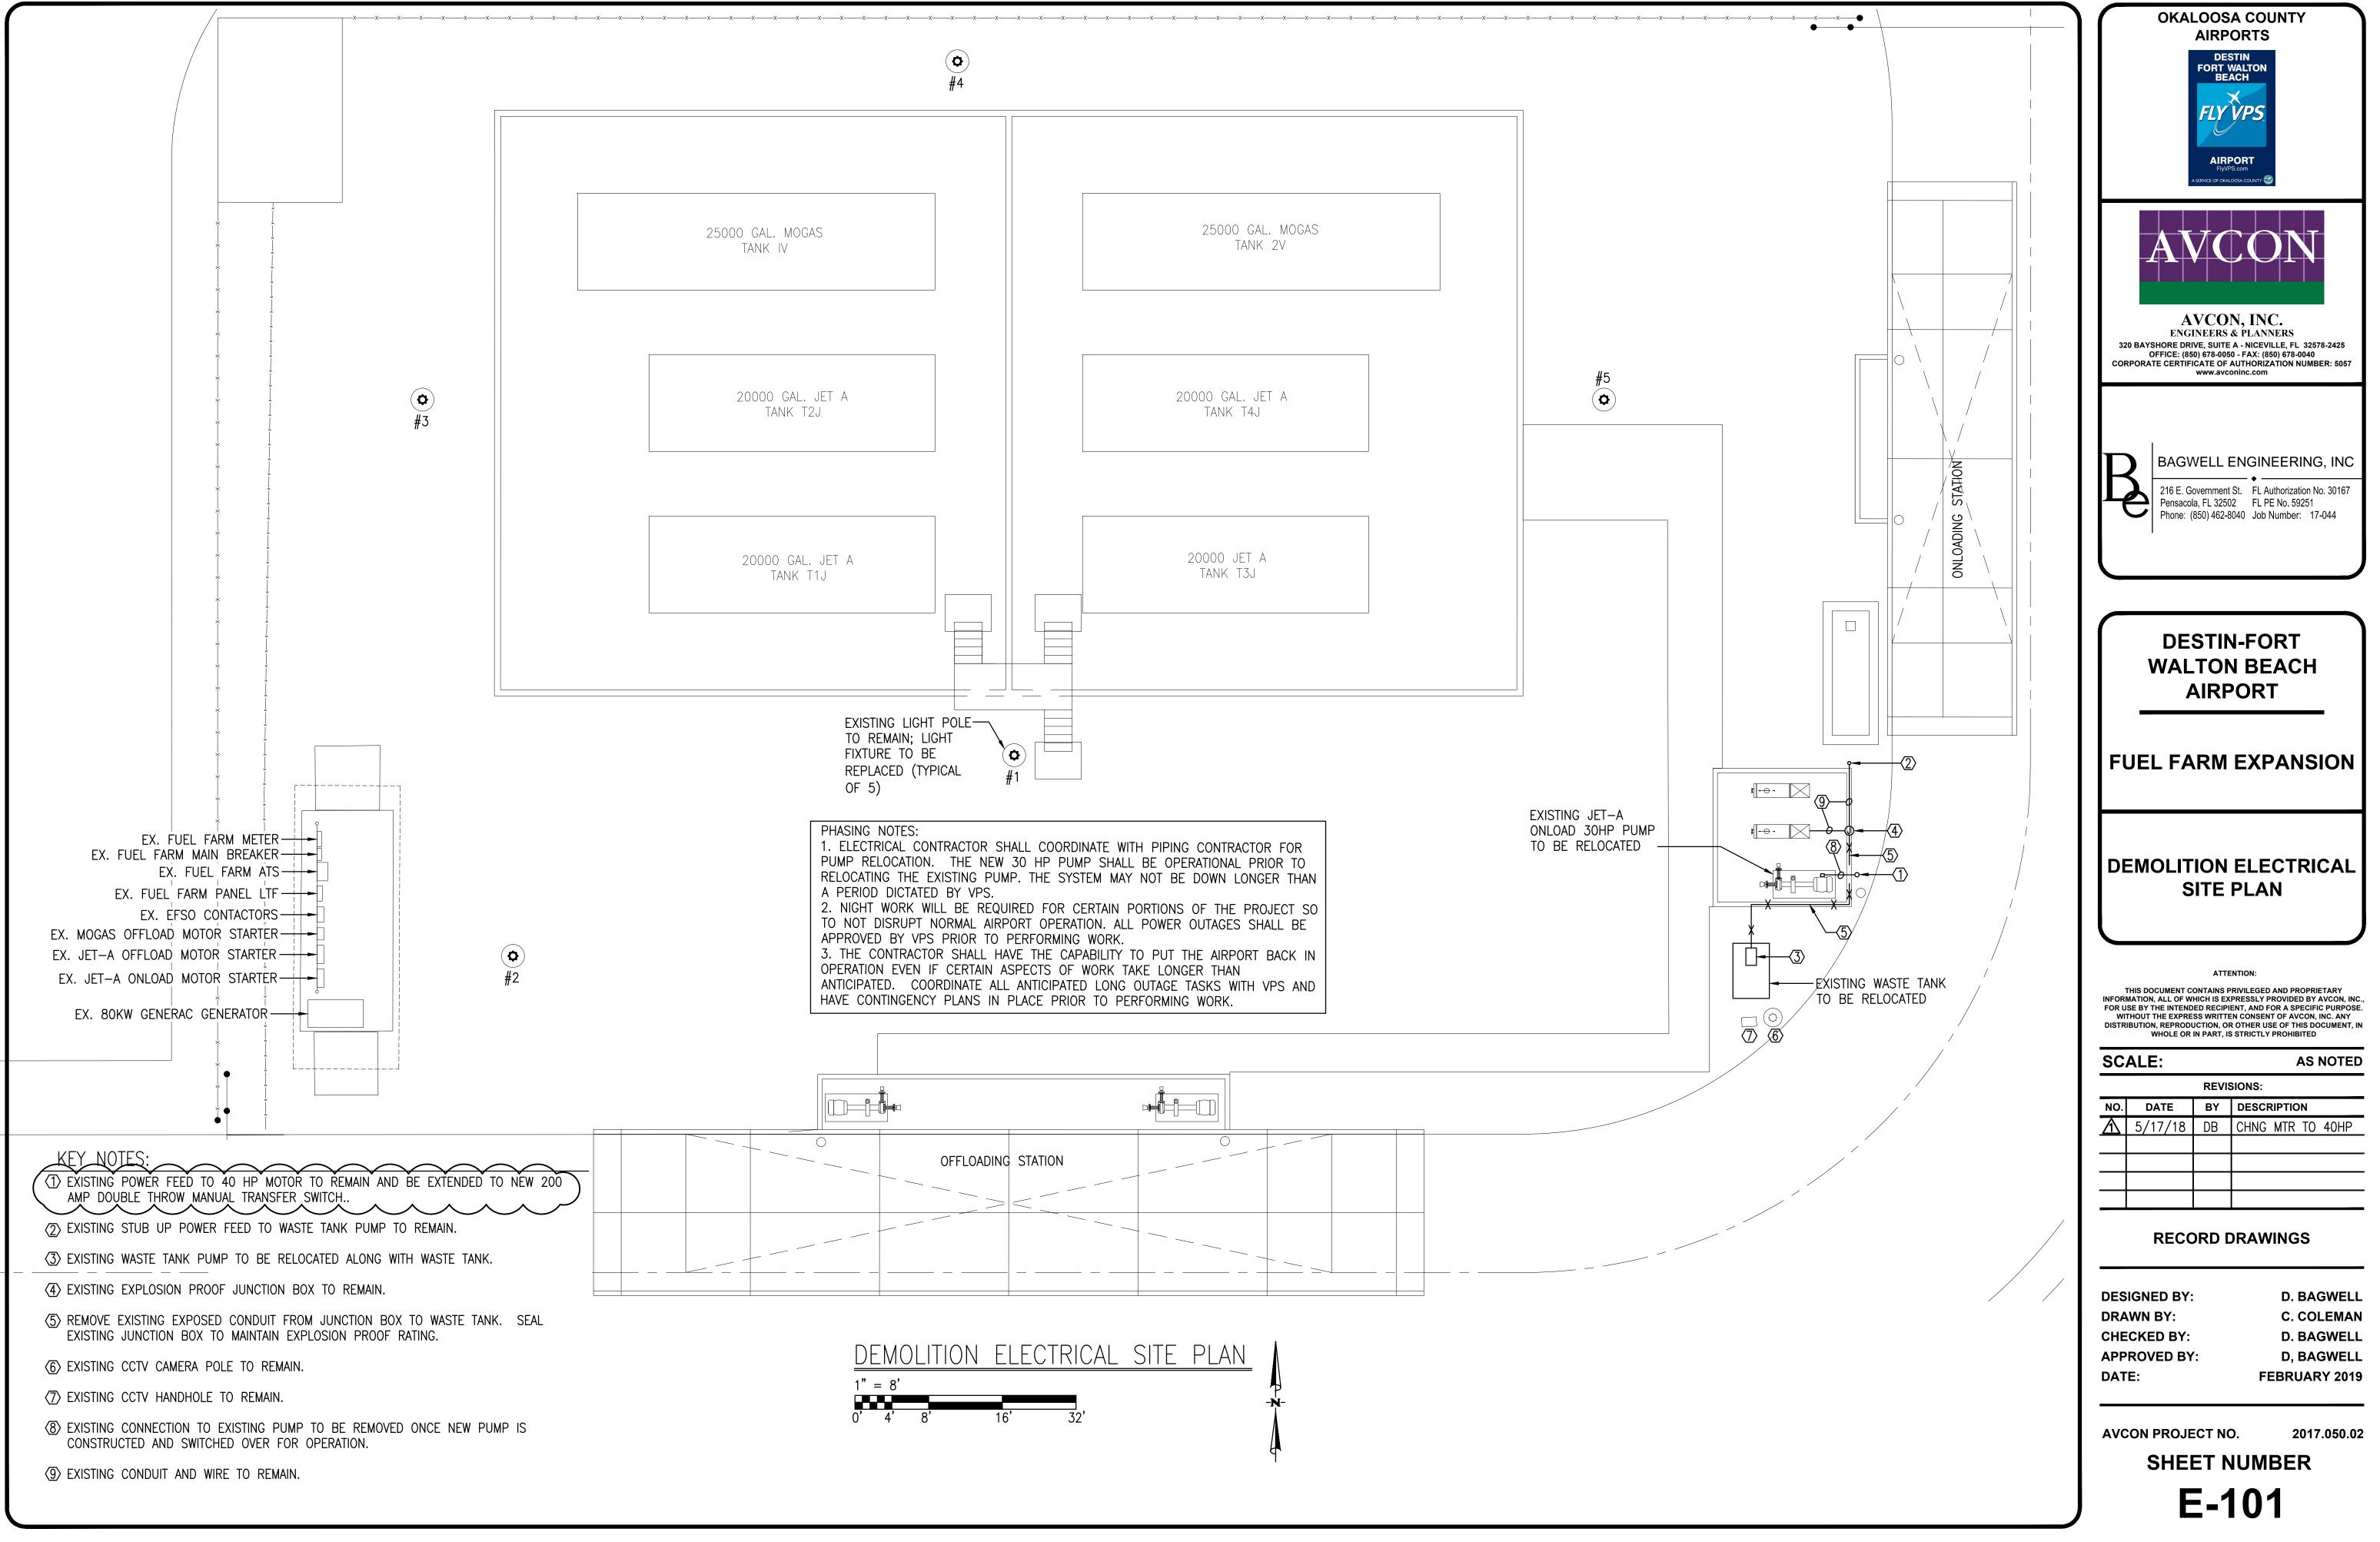
MINIMUM AIC RATING: 10 KAIC RCUIT DEVICE POLES AMP TRIP LIGHTS 2 20 LIGHT CONTROL 1 20 OT ALARM 20 1 | ROL RECEPT 1 20 20 1 RATOR SHED 3 60 20 ACTUATOR 1 20 1 EPTACLES 20 1 · 1 \_] HTS 20 SPACE SPACE OAD PUMP 3 125

SHEET NUMBER




017\044-VPS FUELS PROJECT\DRAWINGS\ELECTRICAL February 5


		OKALOOSA COUNTY AIRPORTS
		DESTIN FORT WALTON BEACH
		FLY VPS
		AIRPORT FlyVPS.com A service of okaloosa county
		AVCON
	INFORMATION	
	1	AVCON, INC.
	RISER-FOR	ENGINEERS & PLANNERS 320 BAYSHORE DRIVE, SUITE A - NICEVILLE, FL 32578-2425 OFFICE: (850) 678-0050 - FAX: (850) 678-0040 CORPORATE CERTIFICATE OF AUTHORIZATION NUMBER: 5057
		www.avconinc.com
	EXISTING	
P-6 DIESEL		BAGWELL ENGINEERING, INC
ΤΑΝΚ		216 E. Government St. FL Authorization No. 30167
		Pensacola, FL 32502 FL PE No. 59251 Phone: (850) 462-8040 Job Number: 17-044
6 & 1#10GND IN 2"C FOR MOTOR 14 FOR MOTOR HEATER		
14 FOR MOTOR HIGH TEMP SWITCH 14 FOR "RUN" PILOT LIGHT		
14 FOR FLOW SWITCH 14 FOR "RUN" & "STOP" PILOT LIGHTS		
14 FOR "START" & "STOP" PUSHBUTTONS 14 FOR GROUND VERIFICATION UNITS		DESTIN-FORT WALTON BEACH
2 & 1#8GND IN 2"C FOR MOTOR		AIRPORT
14 FOR MOTOR HEATER 14 FOR MOTOR HIGH TEMP SWITCH		
14 FOR "RUN" PILOT LIGHT 14 FOR FLOW SWITCH	İ	FUEL FARM EXPANSION
14 FOR "RUN" & "STOP" PILOT LIGHTS 14 FOR "START" & "STOP" PUSHBUTTONS		
14 FOR GROUND VERIFICATION UNITS		
1/0 & 1#6GND IN 2"C FOR MOTOR 14 FOR MOTOR HEATER		
14 FOR MOTOR HIGH TEMP SWITCH 14 FOR "RUN" PILOT LIGHT		POWER RISER
14 FOR FLOW SWITCH 14 FOR "RUN" & "STOP" PILOT LIGHTS		
14 FOR "START" & "STOP" PUSHBUTTONS 14 FOR GROUND VERIFICATION UNITS		ATTENTION:
14 FOR "RUN" & "STOP" PILOT LIGHTS		THIS DOCUMENT CONTAINS PRIVILEGED AND PROPRIETARY INFORMATION, ALL OF WHICH IS EXPRESSLY PROVIDED BY AVCON, INC., FOR USE BY THE INTENDED RECIPIENT, AND FOR A SPECIFIC PURPOSE.
14 FOR "START" & "STOP" PUSHBUTTONS 14 FOR GROUND VERIFICATION UNIT		WITHOUT THE EXPRESS WRITTEN CONSENT OF AVCON, INC. ANY DISTRIBUTION, REPRODUCTION, OR OTHER USE OF THIS DOCUMENT, IN WHOLE OR IN PART, IS STRICTLY PROHIBITED
12GND IN 3/4"C		SCALE: AS NOTED
MOGAS		REVISIONS: NO. DATE BY DESCRIPTION
FFLOAD ST		▲ 5/17/18 DB CHNG MTR TO 40HP
JET-A FFLOAD ST	İ	
JET-A		
ILL STAND		RECORD DRAWINGS
NG RISER-FOR INFORMATION ONLY		DESIGNED BY: D. BAGWELL
ORK RISER & 1#6 GND IN 2"C	$\langle$	DRAWN BY:C. COLEMANCHECKED BY:D. BAGWELL
	IA 4 <	APPROVED BY: D, BAGWELL DATE: FEBRUARY 2019
MANUAL TRANSFER SWITCH WITH 'ON' 'OFF', 'ON' SWITCH POSITIONS.	, <u> </u>	
	$\langle$	AVCON PROJECT NO. 2017.050.02
40 HP	)	SHEET NUMBER
		<b>E-004</b>



7\044-VPS FUELS PROJECT\DRAWINGS\ELECTRICAL February 5, 201;

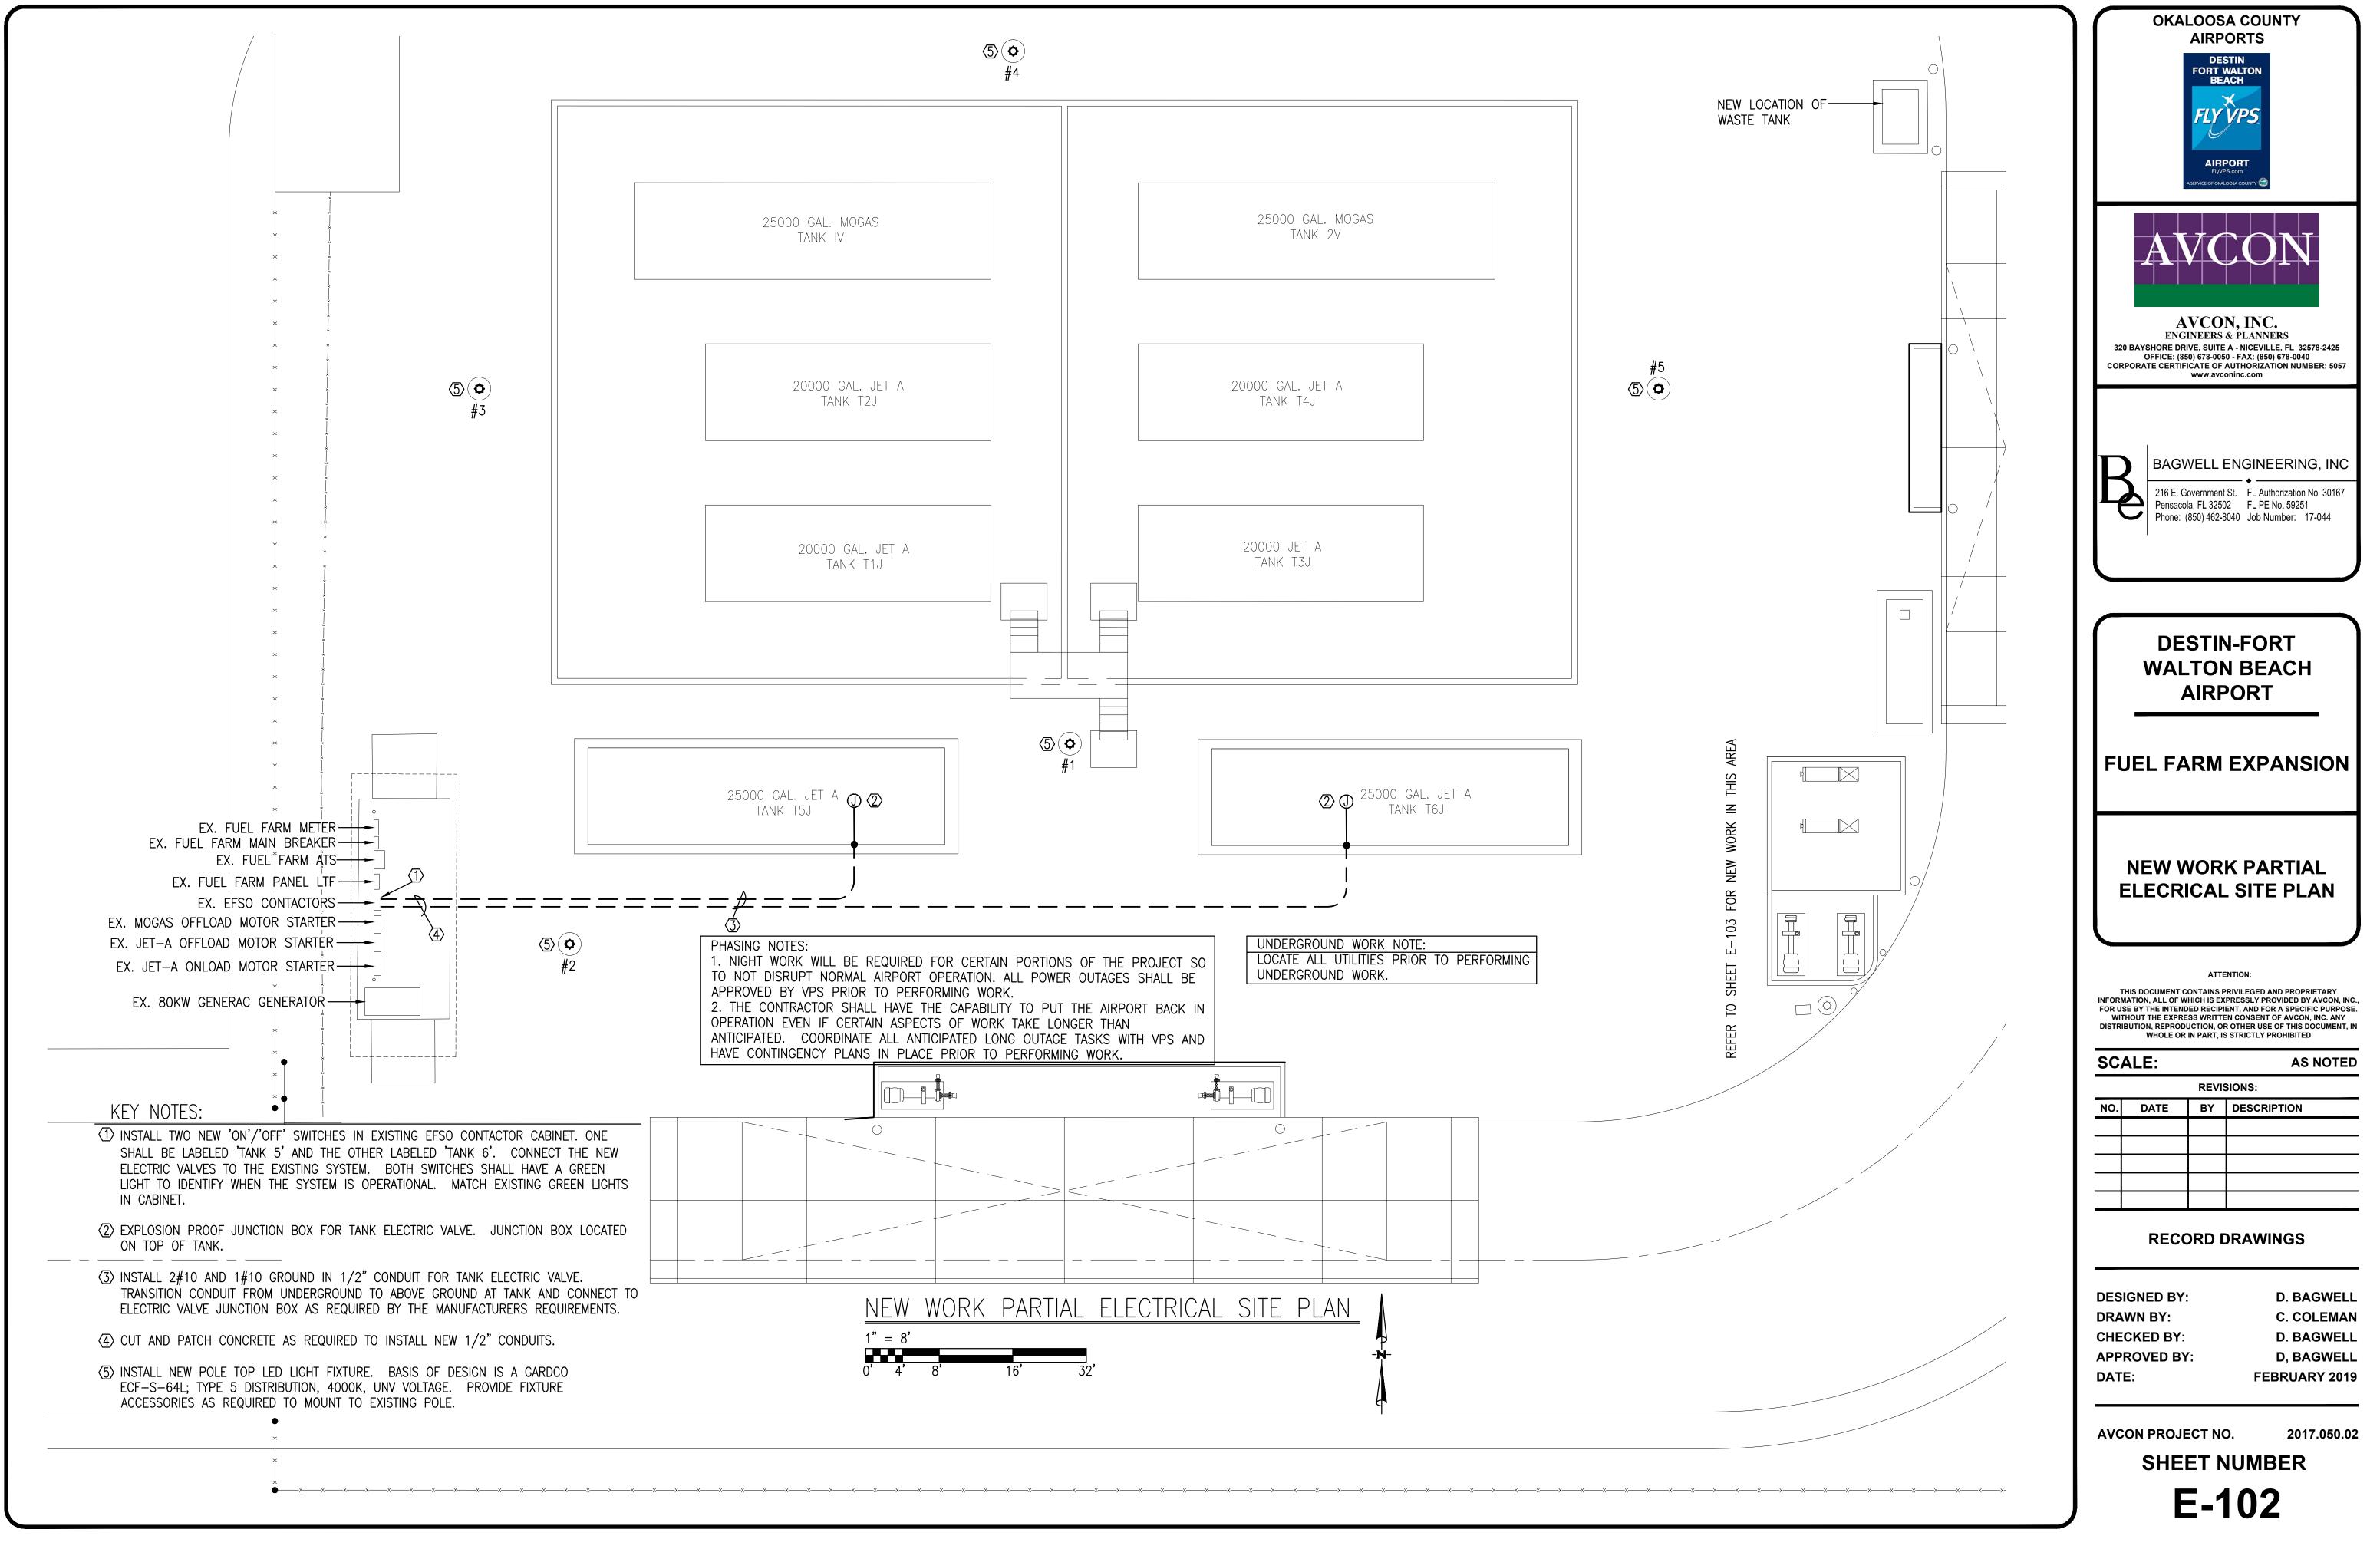

2017\044-VPS FUELS PROJECT\DRAWINGS\ELECTRICAL February 5, 201

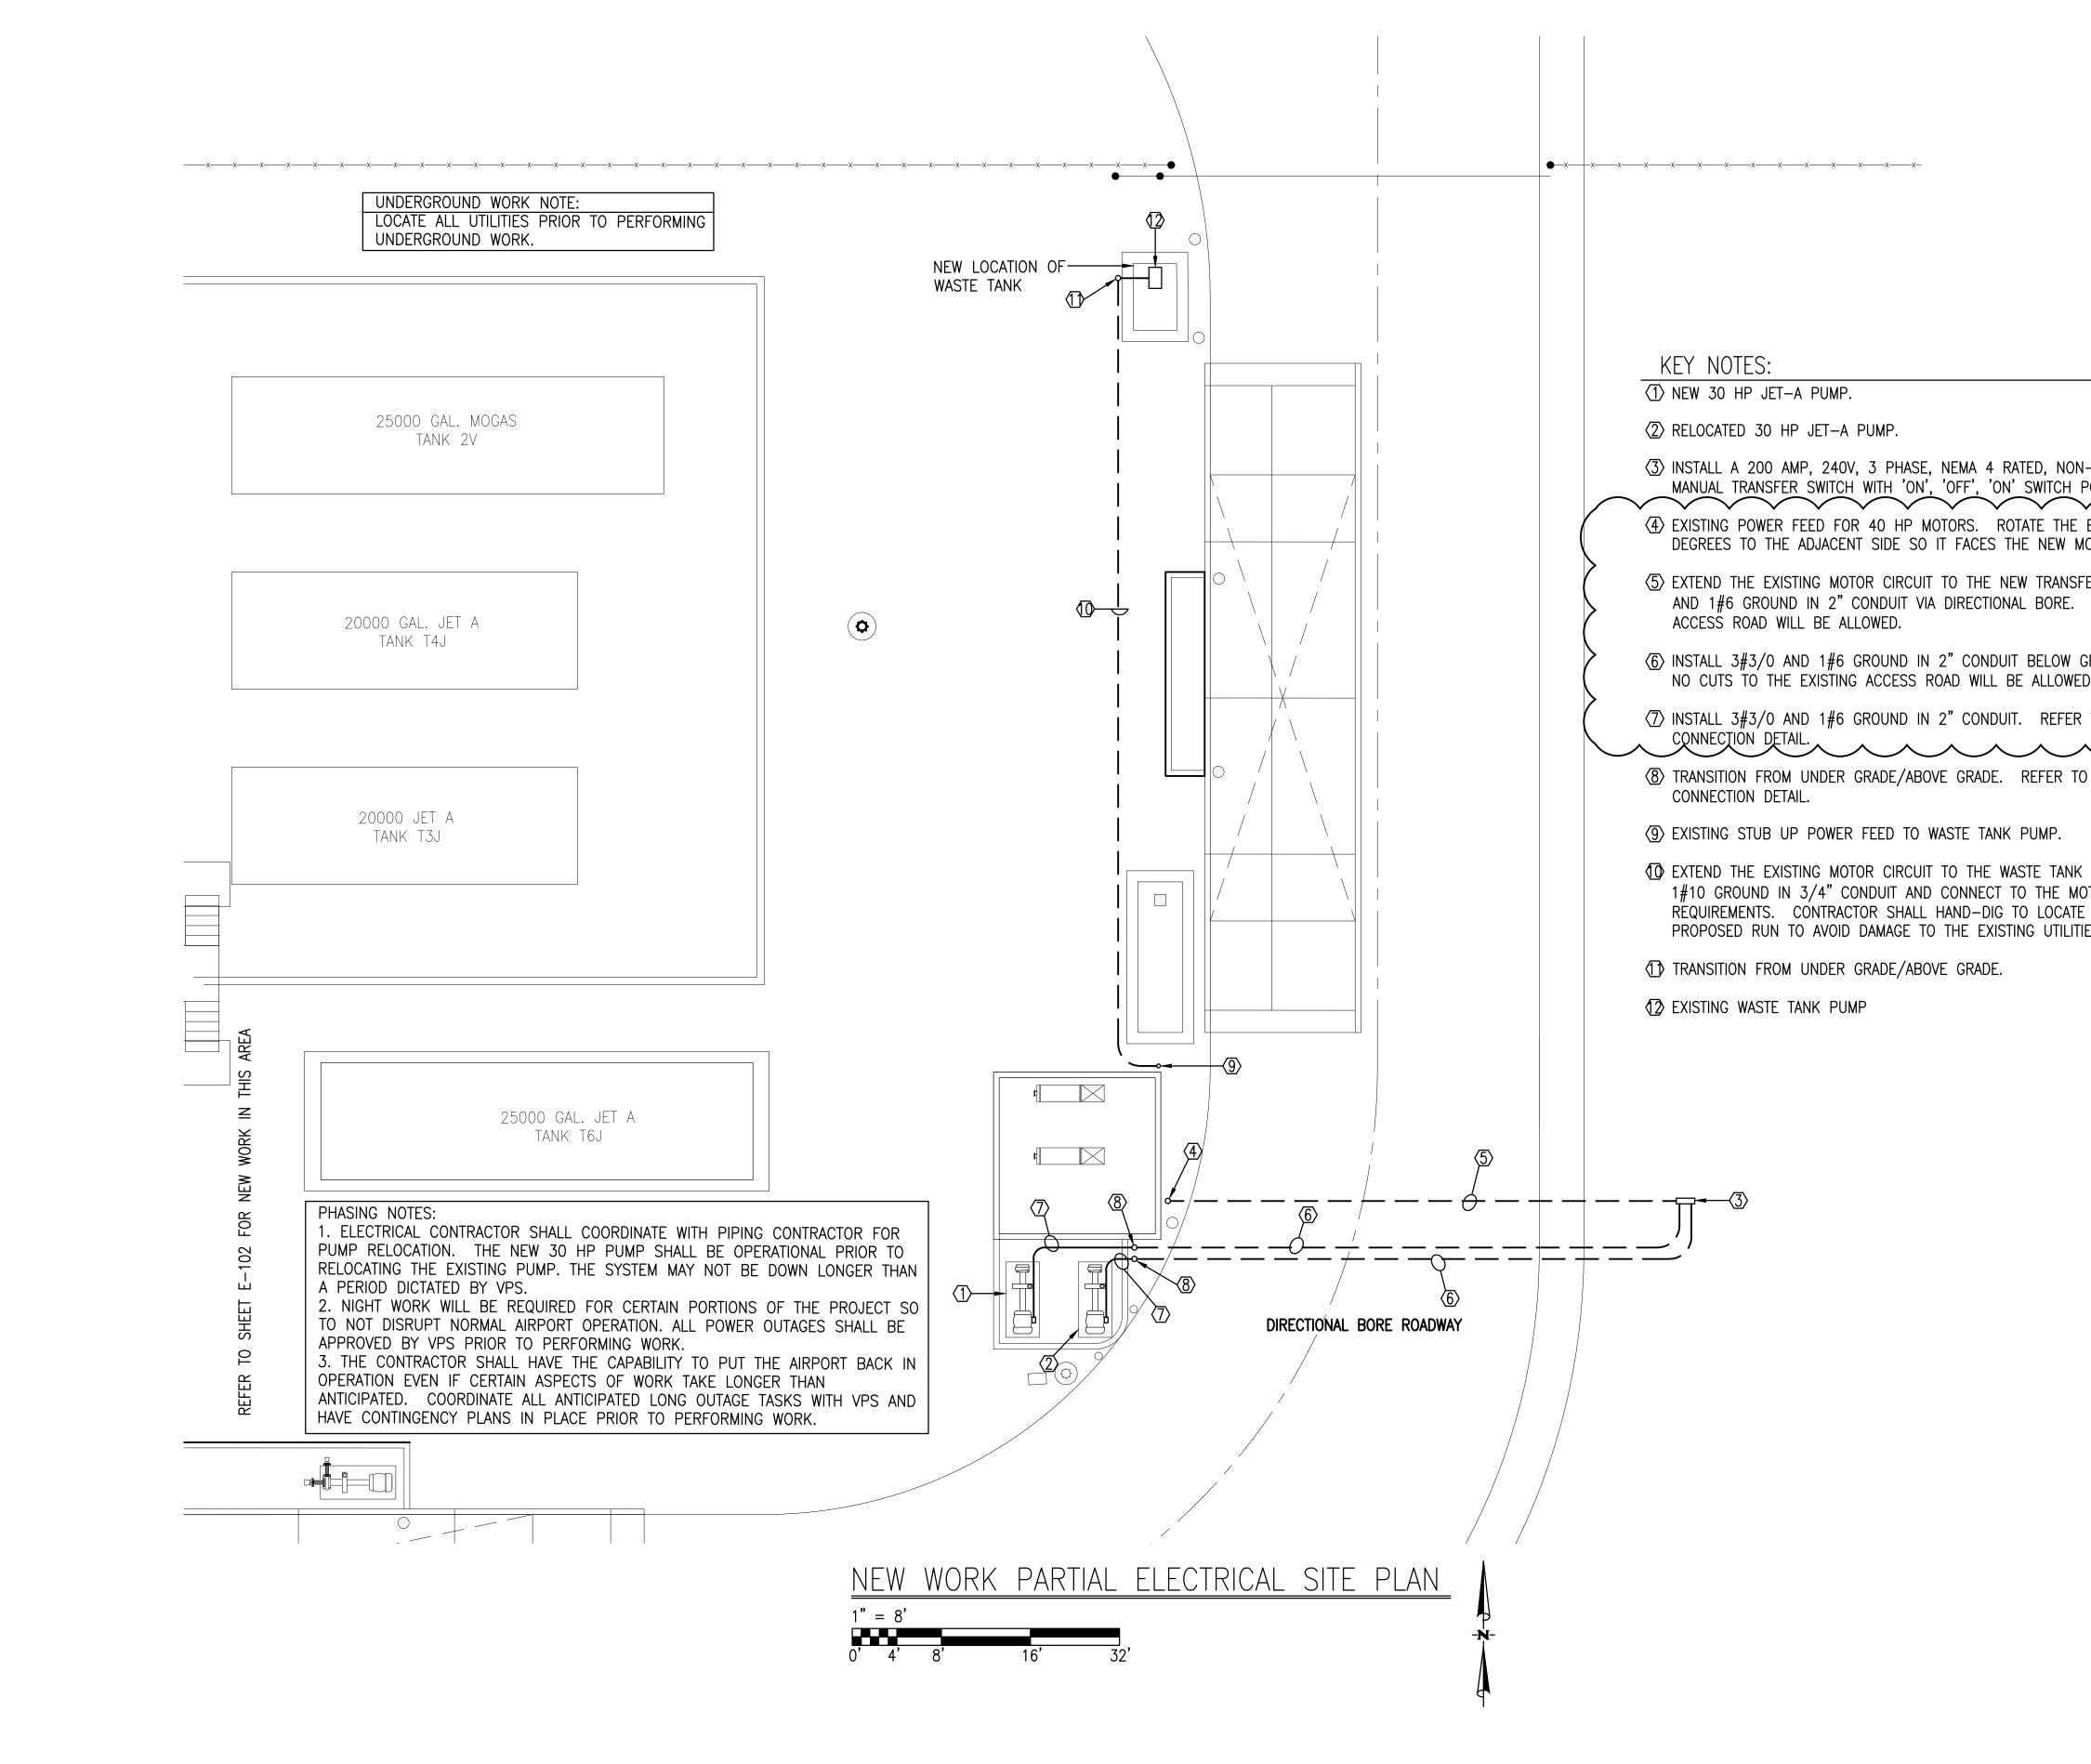

2017/044-VPS FUELS PROJECT\DRAWINGS\ELECTRICAL February 5, 201

	AIRPORTS
	DESTIN FORT WALTON BEACH FIVE OF OKALOOSA COUNTY
	AVCON AVCON, INC. ENGINEERS & PLANNERS
	320 BAYSHORE DRIVE, SUITE A - NICEVILLE, FL 32578-2425 OFFICE: (850) 678-0050 - FAX: (850) 678-0040 CORPORATE CERTIFICATE OF AUTHORIZATION NUMBER: 5057 www.avconinc.com
USED DOUBLE THROW	
ISTING RUN LIGHT 180 DR LOCATIONS.	BAGWELL ENGINEERING, INC 216 E. Government St. Pensacola, FL 32502 + FL Authorization No. 30167 FL PE No. 59251
SWITCH. INSTALL 3#3/0 O CUTS TO THE EXISTING	Phone: (850) 462-8040 Job Number: 17-044
DE VIA DIRECTIONAL BORE.	
) JET-A ONLOAD PUMP	DESTIN-FORT WALTON BEACH
ET-A ONLOAD PUMP	AIRPORT
JMP. INSTALL 2#10 AND R PER THE MANUFACTURERS LL UTILITIES ALONG THE SHOWN ON SHEET C—4.	FUEL FARM EXPANSION
R PER THE MANÜFACTURERS	FUEL FARM EXPANSION NEW WORK PARTIAL ELECTRICAL SITE PLAN
R PER THE MANÜFACTURERS LL UTILITIES ALONG THE	NEW WORK PARTIAL         BLECTRICAL SITE PLAN         LIENTIC         NIS DOCUMENT CONTAINS PRIVILEGED AND PROPRIETARY         INFORMATION, ALL OF WHICH IS EXPRESSLY PROVIDED BY AVCON, INC.         AND USE BY THE INTENDED RECIPIENT, AND FOR A SPECIFIC PURPOSE.         WITHOUT THE EXPRESS WRITTEN CONSENT OF AVCON, INC. ANY
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